




Macomb County, Michigan

CLINTON TWP. FIRE STATION RENOVATIONS

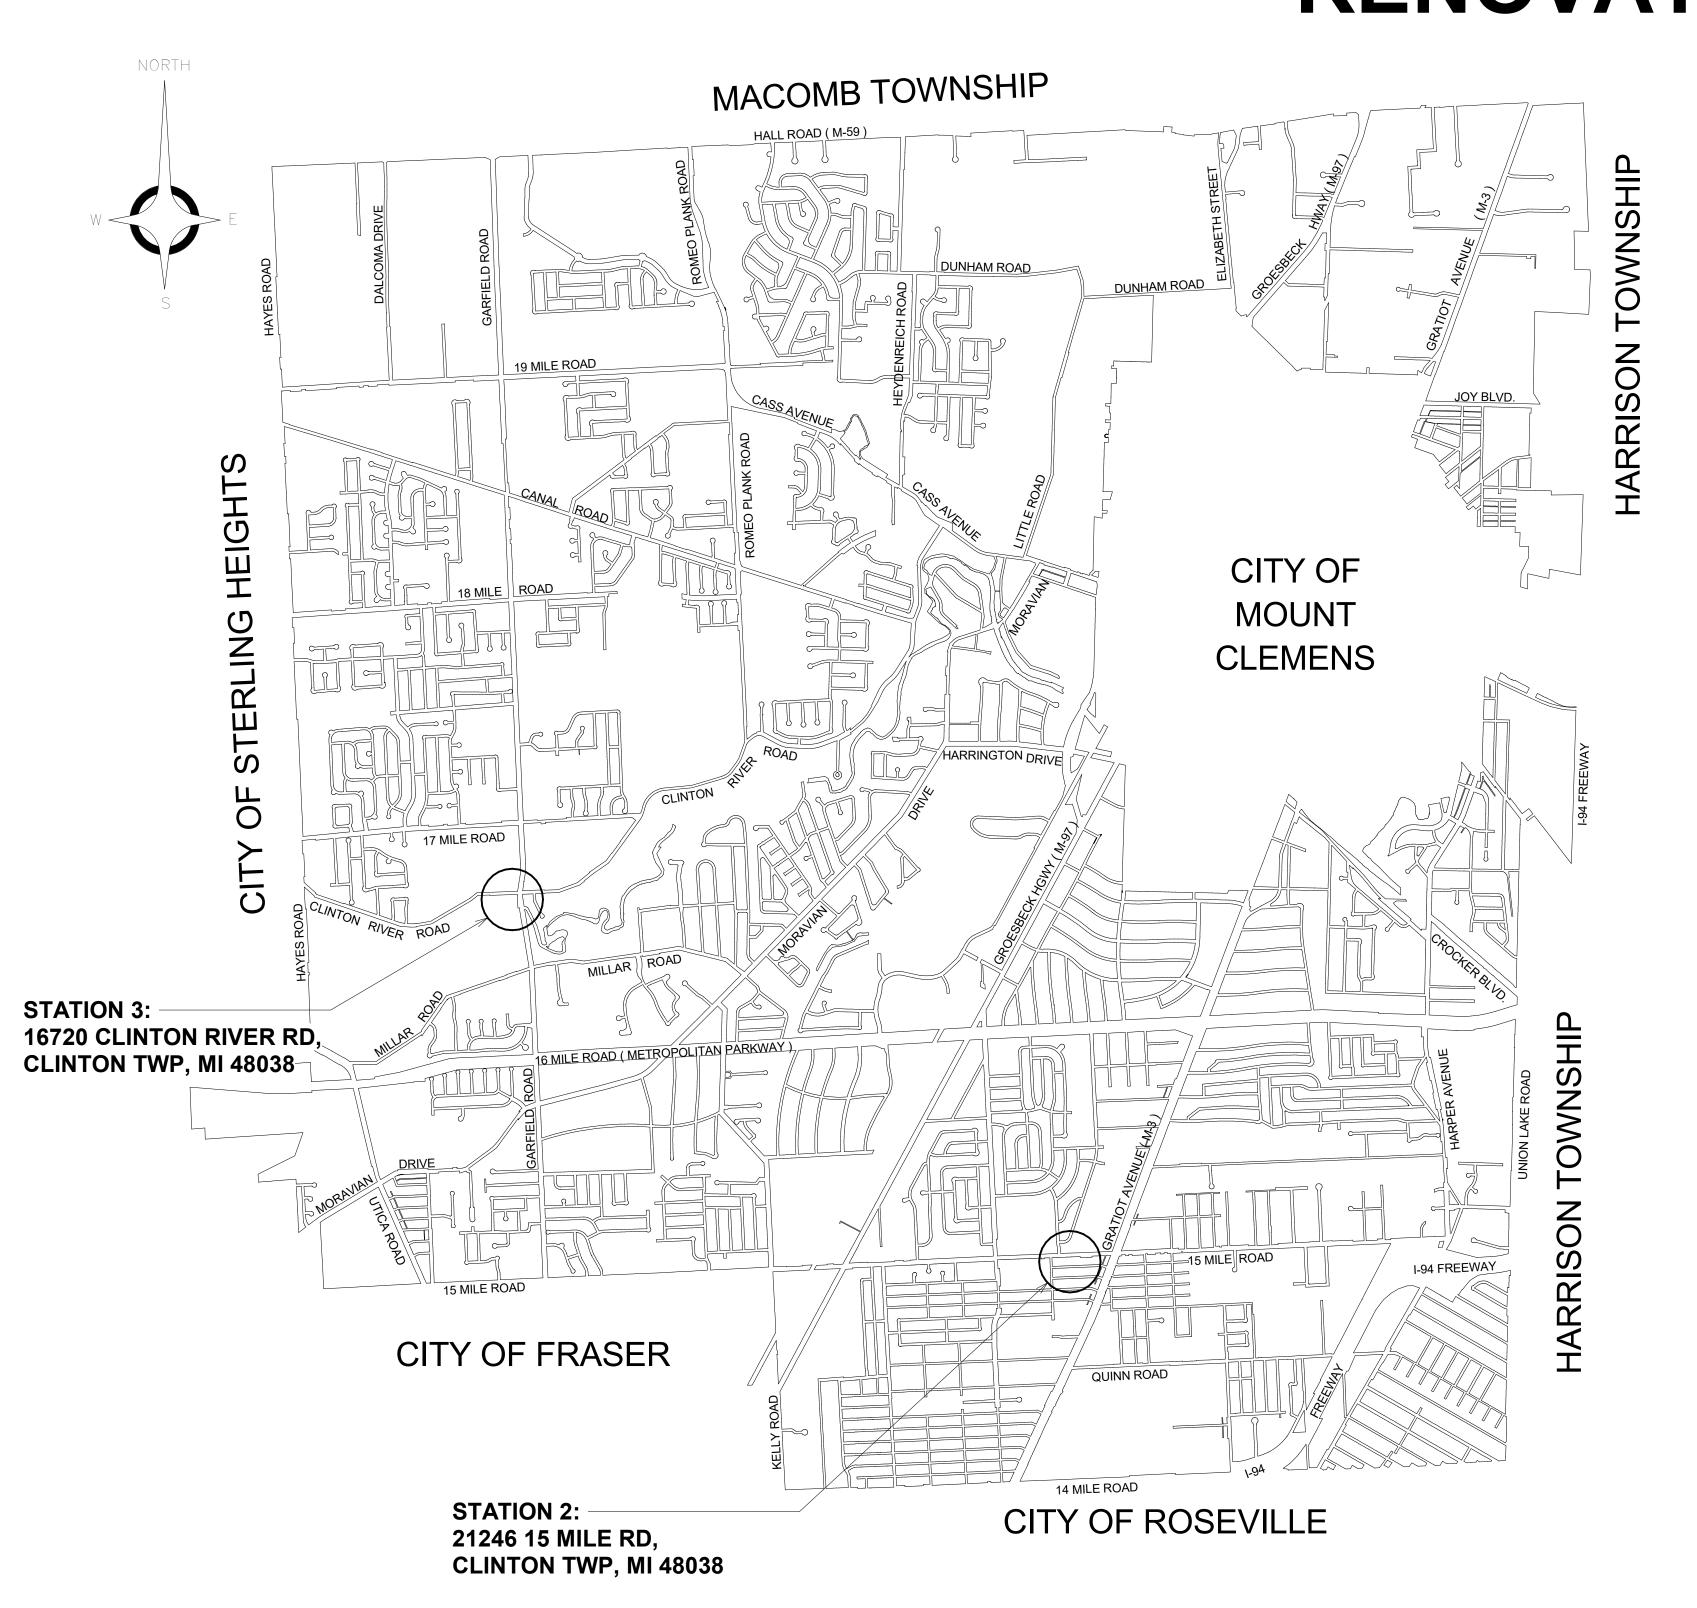


INDEX TO SHEETS

ARCHITECTURAL ADA SPECIFICATIONS SPECIFICATIONS FIRE STATION No. 2 & 3 DEMOLITION PLANS - TOILET/LOCKERS ROOM FIRE STATION 2 & 3 FLOOR AND REFLECTED CEILING PLANS @ TOILET / LOCKER FIRE STATION 2 & 3- INTERIOR ELEVATIONS AND ROOM FINISH SCHEDULE ROOM FINISH SCHEDULE	A021 A031 A032 AD103 A101 A412 A611
PLUMBING STATION 2 & 3 PLUMBING FLOOR PLANS	P101
MECHANICAL FIRE STATION 2 & 3 MECHANICAL FLOOR PLAN - DEMO @ TOILET / LOCKERS ROOM FIRE STATION No. 2 & 3 - HVAC FLOOR PLAN	MD101 M101
ELECTRICAL ELECTRICAL NOTES	E100
COMMAND LOCKER ELECTRICAL DEMO PLANS	ED101
GENERAL ELECTRICAL DEMO PLANS	ED101
COMMAND ELECTRICAL PLANS	E101
GENERAL ELECTRICAL PLANS	E102
ELECTRICAL SCHEDULES	E300

"I HEREBY CERTIFY THESE PLANS HAVE BEEN PREPARED UNDER MY DIRECT SUPERVISION IN ACCORDANCE WITH ACT 240, PUBLIC ACTS OF 1937 AS AMENDED- STATE OF MICHIGAN."

JASON ARLOW, AIA # 1301054547

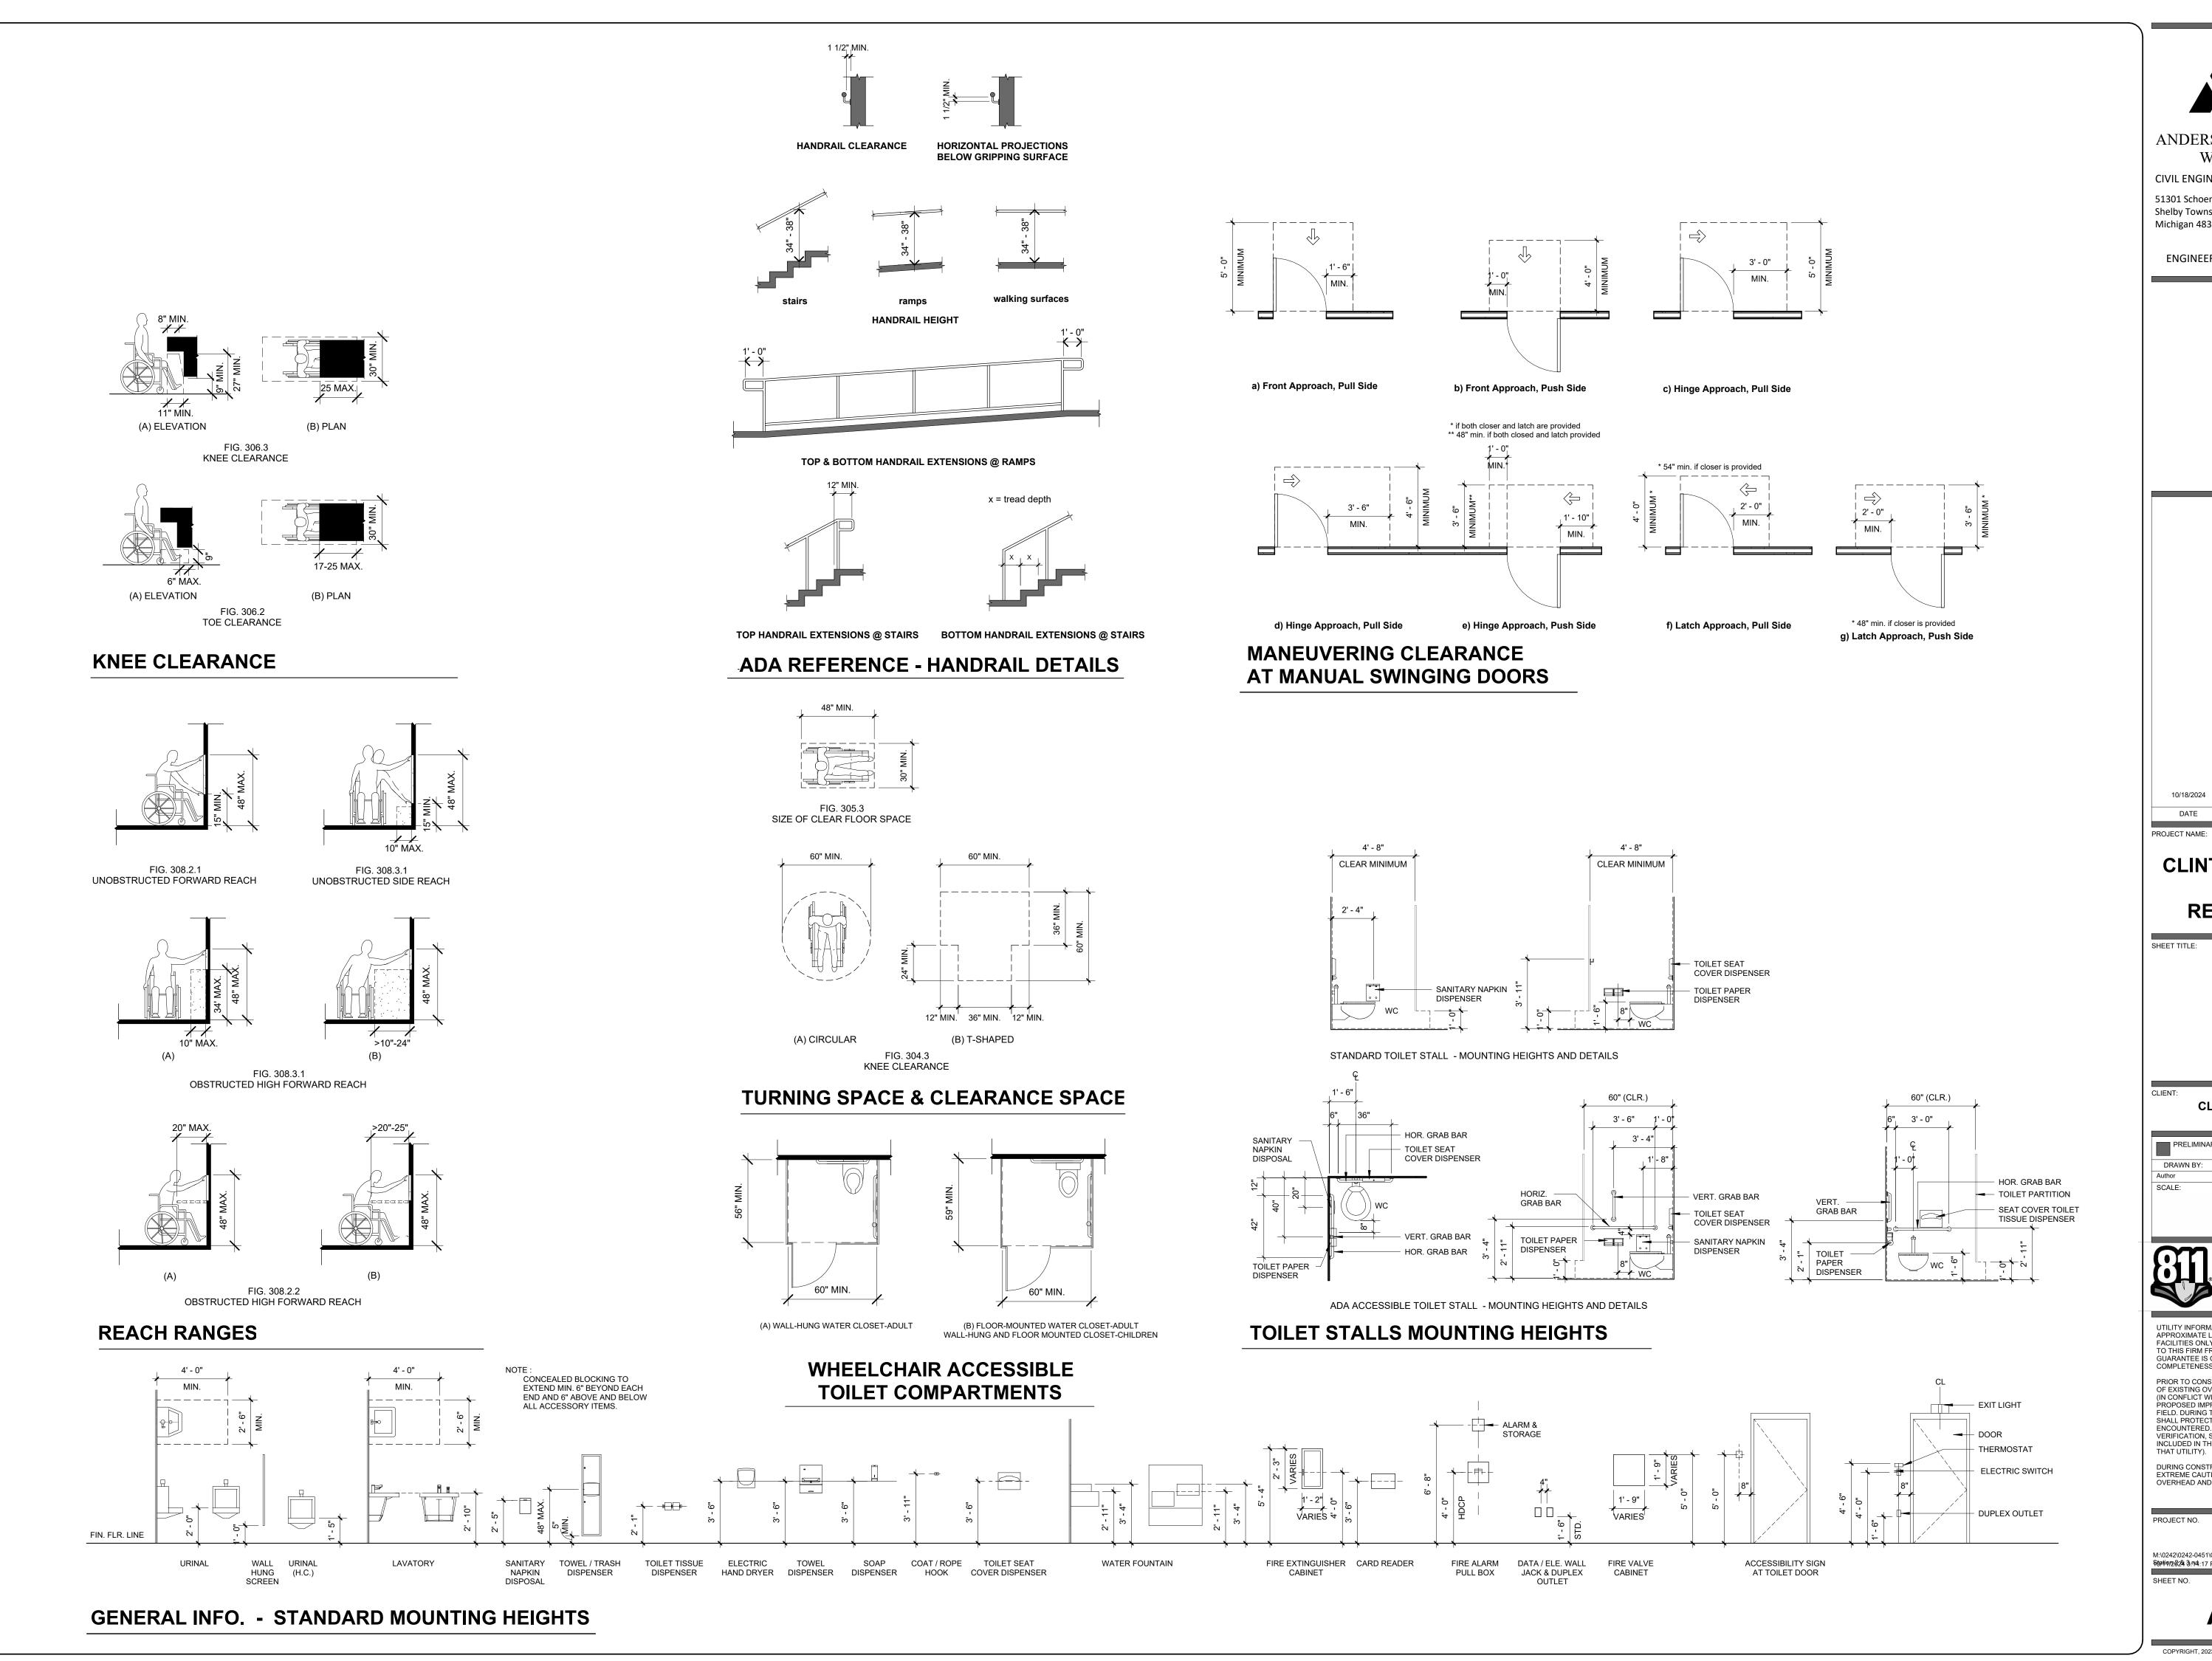



ANDERSON, ECKSTEIN AND WESTRICK, INC.

CIVIL ENGINEERS SURVEYORS ARCHITECTS 51301 Schoenherr Road Phone 586 726 1234 Shelby Township Fax 586 726 8780 Michigan 48315

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ENGINEERING STRONG COMMUNITIES

BID ISSUE 10/18/2024 SUBMITTALS/REVISIONS

CLINTON TWP. FIRE STATION RENOVATIONS

ADA

CLINTON TOWNSHIP

CHECKED BY: 03/01/2023 SCALE: AS NOTED

Know what's below. Call 72 hours before you dig.

UTILITY INFORMATION, AS SHOWN, INDICATES APPROXIMATE LOCATIONS AND TYPES OF EXISTING FACILITIES ONLY, AS DISCLOSED BY RECORDS PROVIDED TO THIS FIRM FROM THE VARIOUS UTILITY COMPANIES. NO GUARANTEE IS GIVEN OR IMPLIED AS TO THE COMPLETENESS OR ACCURACY THEREOF.

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DURING CONSTRUCTION, THE CONTRACTOR SHALL USE EXTREME CAUTION WHEN OPERATING NEAR ANY AND ALL OVERHEAD AND / OR BURIED UTILITIES.

PROJECT NO.

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GENERAL TRADES SPECIFICATIONS

DIVISION 1 - GENERAL REQUIREMENTS : 1. ALL WORK SHALL COMPLY WITH STATE AND LOCAL BUILDING CODES AS THEY APPLY. 3. CONTRACTOR IS RESPONSIBLE FOR ALL PERMITS, FEES AND INSPECTIONS. **DIVISION 3 - CONCRETE**: **DIVISION 4 - MASONRY :** DIVISION 5 - METALS : **DIVISION 6 - CARPENTRY:** BACKSPLASH AS INDICATED ON DRAWINGS B. CARLISLE B. OWENS CORNING

- 2 ALL PROVISIONS OF "DIVISION 0" BIDDING REQUIREMENTS, CONTRACTS, FORMS AND CONDITIONS OF CONTRACT
- AND "DIVISION 1" GENERAL REQUIREMENTS, FORM A PART OF EACH DIVISION GIVEN ON THIS DRAWING SHEET.
- 4. CONTRACTOR IS REQUIRED TO CARY WORKERS, LIABILITY, AND BUILDERS RISK INSURANCE POLICIES.
- 5. CONTRACTORS AND SUBCONTRACTORS SHALL PROVIDE ALL WORK SHOWN IN ANY PART OF THE DOCUMENTS, I.E. HAND DRYER SHOWN ON ARCHITECTURAL DRAWINGS MUST BE WIRED BY THE ELECTRICIAN WHETHER IT IS OR IS NOT SHOWN ON THE ELECTRICAL DRAWINGS.
- 6. CONTRACTOR SHALL PROVIDE A MIN. 2 YEAR WARRANTY ON ALL MATERIAL, EQUIPMENT AND WORK PERFORMED.

- 1. LIGHT-GAUGE METAL FRAMING- COMPLY WITH THE APPLICABE REQUIREMENTS OF THE MICHIGAN BUILDING CODE AND THE AMERICAN IRON AND STEEL INSTITUTE 'S 'SPECIFICATIONS FOR THE DESIGN OF COLD-FORMED STEEL STRUCTURAL MEMBERS', THE CENTER FOR COLD-FORMED STEEL STRUCTURES 'TECHNICAL BULLETIN VOL. 2 NO. 1, 1996, AND AIAI SPEIFICATION PROVISIONS FOR SCREW CONNECTIONS.
 - A. COLD-FORMED METAL FRAMING SHALL BE OF THE SIZE, GAUGE AND SECTION PROPERTIES AS REQUIRED FOR THE SPECIFIC LOADING CONDITION AND CONFORM TO ASTM A653. ALL FRAMING 16 GAUGE AND HEAVIER SHALL HAVE A MINIMUM YIELD STRENGTH OF 50 KSI. ALL FRAMING 18 GAUGE AND LIGHTER SHALL HAVE A MINIMUM YIELD STRENGTH OF 33 KSI. ALL FRAMING SHALL BE HOT DIPPED GALVANIZED (G-60) IN ACCORDANCE WITH ASTM A924.
 - B. WELDING OF LIGHT-GAUGE METAL FRAMING SHALL NOT BE PERMITTED.
 - ALL LIGHT-GAUGE METAL FRAMING SHALL BE SAW CUT, SQUARE AND TRUE. CUTTING OF FRAMING WITH A TORCH WILL NOT BE PERMITTED.
 - D. NO SPLICES WILL BE PERMITTED IN ANY FRAMING UNLESS SHOWN OR NOTED ON DRAWINGS.
 - E. CONNECTIONS FOR LIGHT-GAUGE FRAMING SHALL BE AS MANUFACTURED BY THE STEEL NETWORK, INC. OR APPROVED EQUAL.
- 1. PLASTIC LAMINATE MILLWORK- HIGH-PRESSURE DECORATIVE LAMINATE ADHERED FULLY TO MEDIUM DENSITY PARTICLEBOARD (ANSI A208.1 GRADE M2 or BETTER) WITH ADHESIVE RECOMMENDED BY THE LAMINATE MANUFACTURER TO SUIT APPLICATION. ASSEMBLE WITH CONCEALED CONNECTORS. INCLUDE LAMINATE AT ALL EXPOSED SURFACES. APPROVED LAMINATE MANUFACTURER: PIONITE, WILSON ART, FORMICA, NEVAMAR OE APPROVED EQUAL. SPECIFIC MODEL NO. AS SELECTED BY ARCHITECT FROM MANUFACTURER'S STANDARD FINISH SELECTIONS.
- 2. SOLID SURFACE COUNTERTOP- CORIAN SOLID SURFACE AS MANUFACTURED BY DUPONT CORP. COLOR TO BE SELECTED BY ARCHITECT. FORM EDGES AND

<u>DIVISION 7 - THERMAL AND MOISTURE PROTECTION :</u>

1. WATERPROOFING MEMBRANE- PLIABLE SHEET-APPLIED POLYETHYLENE WATERPROOFING MEMBRANE FOR USE BEHIND MORTAR BED IN TILED SHOWERS. APPROVED MANUFACTURER/ MODEL: SCHLUTER-KERDI AS MANUFATCURED BY SHLUTER SYSTEMS INC., OR APPROVED EQUAL

DIVISION 7 - THERMAL AND MOISTURE PROTECTION:

- 1. REFER TO "MATERIAL AND INSTALLATION NOTES" ON DRAWINGS.
- 2. MEMBRANE ROOFING SHALL BE 15 YEAR 60 MIL. FULLY ADHERED EPDM. APPROVED MANUFACTURERS AS FOLLOWS (OR APPROVED EQUAL): A. FIRESTONE
- 3. SHINGLE ROOFING SHALL BE ARCHITECTURAL GRADE DIMENSIONAL 300 LB SEAL DOWN SHINGLE OVER 15# FELT. PROVIDE BITHUTHENE "ICE DAM" AT ALL EVES AND VALLEYS. APPROVED MANUFACTURERS AS FOLLOWS (OR APPROVED EQUAL):
- 4. BASE DAMPPROOFING SHALL BE 20 MIL FLEXIBLE PLASTIC.
- 5. LINTEL FLASHING SHALL BE 2 OUNCE COPPER BONDED TO 3 OUNCE WATER- PROOFED KRAFT PAPER OR EQUAL BY AN APPROVED MANUFACTURER.
- 6. CAULK DOOR AND WINDOW FRAMES AT MASONRY WALLS. CAULK COMPOUND SHALL BE AN ELASTIC, WATERPROOF ADHESIVE FROM AN APPROVED MANUFACTURER. COLOR SELECTION BY ARCHITECT.
- 7. INSULATION
- A. ROOF INSULATION MIN. (R = 38) B. PERIMETER FOUNDATION INSULATION: 2" EXPANDED POLYSTYRENE OR APPROVED EQUAL INSTALLED BY FOUNDATION CONTRACTOR.
 - STUD WALL INSULATION (MIN.) R = 20 ISO BOARD CONTINUOUS ABOVE METAL DECK (MIN.) R = 25
- 8. ROOF CURB SHALL BE PRE FAB CURBS USING MIN. 18 GA. GALVANIZED STEEL. WITH FULLY MITERED AND WELDED CORNERS. CURBS TO BE INSULATED WITH 11/2" RIGID INSULATION AND FACTORY INSTALLED WOOD NAILERS. HEIGHT TO BE 24 INCHES ABOVE ROOF AS DETAILS, CURB SHALL BE LEVEL AT THE TOP.
- 9. TYVEK (BY DUPONT) AIR INFILTRATION BARRIER OVER ALL EXTERIOR SHEATHING.

DIVISION 8 - OPENINGS :

HOLLOW METAL DOOR FRAMES: 18 GA. (MIN.) STEEL WITH ZINC COATING AND FACTORY BAKED - ON PRIMER. CONFORM TO REQUIREMENTS OF ANSI À250.8. FABRICATE TO SUIT MASONRY WALL CAUSING (4 IN. HEAD MEMBER) AT MASONRY WALLS, AND WITH HOLES FOR SILENCERS. APPROVED MANUFACTURERS: STEELCRAFT, CURRIES OR APPROVED EQUAL (MUST BE MEMBER OF STEEL DOOR INSTITUTE). COORDINATE DOORS WITH FINISH HARDWARE.

2. COORDINATE DOORS WITH FINISHED HARDWARE.

- 3. ALL LOCKS SHALL BE MASTER KEYED AND KEYED ALIKE, AS DIRECTED BY OWNER AND ARCHITECT. COORDINATE WITH EXISTING KEY SYSTEM.
- 4. INTERIOR WOOD DOORS: 1 3/4" INCHES THICK, SOLID CORE CONSTRUCTION, 5- PLY, WHITE OAK VENEER PLAIN SLICED W/ PAIR MATCHED GRAIN, PRE-FINISHED STAINED FROM MANUFACTURERS STANDARD COLORS
- APPROVED MANUFACTURERS AS FOLLOWS (OR APPROVED EQUAL): ALGOMA HARDWOODS
- MANSFIELD DOOR SYSTEMS MOHAWK

HARDWARE:

- 1. CONTRACTOR SHALL VERIFY ALL EXISTING FIELD CONDITIONS AND NOTIFY ARCHITECT IMMEDIATELY IF THAT WHICH EXISTS DIFFERS FROM THAT WHICH IS SHOWN ON DRAWINGS.
- 2. ALL WORK TO COMPLY WITH CURRENT FEDERAL, STATE AND LOCAL CODES, LAWS AND ORDINANCES. THE REQUIREMENTS OF ICC/ANSI A117.1 AND THE AMERICANS WITH DISABILITIES ACT (ADA) ARE TO BE FULLY SATISFIED. ALL WORK SHALL MEET THE MOST STRINGENT REQUIREMENTS OF BOTH INCLUDING, BUT NOT LIMITED TO CLEARANCES, LIMITATIONS, ACCESSORIES, ETC.
- 3. THESE DRAWINGS ARE PREPARED IN ACCORDANCE WITH THE LIMITED SERVICES FOR WHICH THE ARCHITECT WAS CONTRACTED. THE ARCHITECT MAKES NO REPRESENTATION THAT THE INTERPRETATION OF THESE DOCUMENTS WILL RESULT IN COMPLETE COMPLIANCE WITH THE ADA.
- 4. ALL DOORS REQUIRED TO BE LABELED SHALL BE SET IN LABELED FRAMES AND IDENTIFIED WITH UL LABEL AND BE PROVIDED WITH APPROVED SELF-CLOSING DEVICES AND POSITIVE LATCHING HARDWARE.
- 5. ALL DESIGNATED EXIT DOORS SHALL BE EQUIPPED WITH THE REQUIRED EGRESS HARDWARE.
- 6. FURNISH HARDWARE AS SCHEDULED WITHOUT SUBSTITUTION, NO ALTERNATES WILL BE APPROVED.
- 7. PROVIDE COMBINATED CYLINDERS AND CUT KEYS; KEYED TO NEW MASTER SYSTEM. INCLUDE KEY CONFERENCE AND KEY SYSTEM SCHEDULE. FURNISH A KEYED CYLINDER AND TWO CUT KEYS FOR EACH LOCKING DEVICE SPECIFIED; PLUS FOUR MASTER KEYS.
- 8. FURNISH AND PROVIDE ALL NECESSARY REINFORCEMENTS, BRACKETS, FASTENERS, SPACERS AND FILLERS O PROVIDE A COMPLETE FUNCTIONING OPENING.
- 9. PROVIDE COMPLETE SHOP DRAWINGS, SUBMITTALS AND CUT SHEETS COMPLYING WITH DHI PRESCRIBED METHODS AND VERTICAL FORMAT DOUBLE SPACED HARDWARE SCHEDULE.

HARDWARE SETS:

```
<u>HARDWARE SET 1</u> – PRIVACY SET W/ INDICATOR [LOCK / UNLOCK]
3 EA. BUTT HINGE BB81 4 ½" X 4 ½" NRP
                                                                  26D PBB
   EA. PRIVACY SET MR 279 BJSJ
                                                                  32D PDQ
1 EA. WALL STOP 1407
                                                                  26D DON JO
```

HARDWARE SET 2 - PRIVACY SET W/ INDICATOR [LOCK / UNLOCK] + CLOSER

3	EA. BUTT HINGE BB51 4 ½" X 4 ½" NRP	32D PBB
1	EA. PRIVACY SET MR 279 BJSJ	32D PDQ
1	EA. CLOSER 7101 BC RA REGULAR ARM (PULL SIDE MOUNT)	689 PDQ
1	EA. KICKPLATE 90 10 X 2" LDW B4E	32D DON JO
1	EA. WALL STOP 1407	26D DON JO

HARDWARE SET 3 - PUSH / PULL SET [ALWAYS UNLOCKED] + CLOSER NEW DOOR IN EXISTING FRAME, MATCH FRAME HAND AND HINGE SIZE / LOCATION. VERIFY EXISTING OPENING AND NOTIFY ARCHITECT IMMEDIATELY IF THAT WHICH EXISTS DIFFERS FROM WHAT IS SPECIFIED BELOW. PATCH-FILL-REPAIR EXISTING PREPS. PREPARE AND INSTALL THE FOLLOWING

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3 EA. BUTT HINGE BB81 4 ½" X 4 ½" NRP
                                                                26D PBB
   EA. PULL PLATE 7137 (MOUNT PRIOR TO PUSH PLATE)
                                                                32D DON JO
   EA. PUSH PLATE 71 (MOUNT OVER PULL FASTENERS)
                                                                32D DON JO
   EA. CLOSER 7101 BC RA REGULAR ARM (PULL SIDE MOUNT)
                                                               689 PDQ
   EA. KICKPLATE 90 10 X 2" LDW B4E
                                                                32D DON JO
1 EA. WALL STOP OR FLOOR STOP – 1407 OR 1441 -TYPE AS REQUIRED 26D DON JO
```

DIVISION 9 - FINISHES :

- 1. GYPSUM BOARD SHALL BE 5/8" THICK MANUFACTURED BY UNITED STATES GYPSUM COMPANY OR EQUAL. USE WATER RESISTANT GREEN BOARD IN TOILET ROOMS AND CEMENT BOARD IN SHOWERS AS SCHEDULED
- ON DRAWINGS. USE 5/8" TYPE "X" FIRECODE BOARD WHERE NOTED.
- METAL TRIM -L TRIM MOLDING BY FRY REGLET OR APPROVED EQUAL. B. ELASTROMERIC EXPANSION JOINT COVER - 75 FWG-DRYWALL BY BALCO, INC. OR APPROVED EQUAL.
- CEMENTITOUS BACKER BOARD- HIGH-DENSITY CEMENTITOUS, GLASS-FIBER REINFORCED, THICKNESS 5/8 " FOR USE AT ALL TILE LOCATIONS. USE COATED GLASS-FIBER TAPE AT JOINTS AND CORNERS, INSTALL PER BACKER BOARD MANUFACTURER INSTRUCTIONS. PAIR WITH SHEET MEMBRANE WATERPROOFING IN SHOWERS.
- APPROVED MODEL / MANUEACTURER DUROCK BRAND CEMENT BOARD BY USG CORP., OR APPROVED EQUAL.
- 3. PAINT FINISHES SHALL BE APPLIED IN ACCORDANCE WITH MANUFACTURER'S SPECIFICATIONS. APPROVED MANUFACTURER'S:
- SHERWIN WILLIAMS
- BENJAMIN MOORE GLIDDEN
- PITTSBURGH PAINTS PRATT & LAMBERT

4. ACOUSTIC CEILING PANEL SYSTEM-

- A. ACOUSTIC CEILING PANEL- WET-FORMED MINERAL FIBER, 2 ' x 2' x 3/4" PANEL WITH TEGULAR EDGE, COLOR- WHITE. MINIMUM NRC/ CAC VALUE OF 0.60/40. APPROVED MANUFACURER/ MODEL: ARMSTRONG 'ULTIMA' TEGULAR
- B. METAL GRID- METAL EXPOSED-TEE SYSTEM, INTERMEDIATE-DUTY, 15/16 " PROFILE, 1 5/8" HIGH, POWDER COAT FINISH, COLOR- WHITE. APPROVED MANUFACTURER/ MODEL: ARMSTRONG 'PRELUUDE XL' ACOUSTICAL SUSPENSION SYSTEM OR APPROVED EQUAL
- INSTALL ALL TILE PER THE LATEST TCI HANDBOOK, INCLUDING BUT NOT LIMITED TO SHOWER LINERS, BACKING MATERIAL AND RECOMMENDED USES. APPROVED MANUFACTURE AS FOLLOWS (OR APPROVED EQUAL):

CROSSVILLE STONEPEAK

6. FLOORING:

A. LUXURY VINYL TILE : LVT - 1: SHAW INLET, STYLE NO. 0926V, PLANKS. COLOR AS PER ARCHITECT / OR OWNER APPROVAL

- CT, BEAVER TILE MILESTONE REVIVAL, IVORY, 12"x24" TILES OR APPROVE EQUAL.

- 1. FLOORS- MODIFIED EPOXY EMULSION TYPE. APPROVED MANUFACTURER/ MODEL: 'CUSTOM BUILDING PRODUCTS 100% SOLIDS EPOXY GROUT' OR APPROVED EQUAL
- 2. WALLS- POLYMER-MODIFIED PORTLAND CEMENT GROUT, SANDED. APPROVED MANUFACTURER/ MODEL: 'CUSTOM BUILDING PRODUCTS POLYBLEND SANDED TILE GROUT' OR APPROVED EQUAL.
- 3. COLOR- SELECTED BY ARCHITECT FROM MANUFACTURER'S STANDARD COLOR SELECTIONS
- RESILIENT BASE: 4" HIGH, VUCANIZED THERMOSET RUBBER, COLOR SELECTED BY ARCHITECT FROM MANUFACTURER 'S STANDARD COLOR SELECTIONS. APPROVED MANUFACTURER/ MODEL: 'ROPPE CORPORATION PINNACLE RUBBER BASE' OR APPROVED EQUAL.

DIVISION 10 - SPECIALTIES :

1. TOILET COMPARTMENTS AND URINAL SCREENS - SOLID, MOLDED THERMOSET, WATERPROOF, HIGH - DENSITY POLYETHYLENE (HDPE) PLASTIC PANELS, DOORS AND PILASTERS. FLOOR-MOUNTED, HEADRAIL - BRACED COMPARTMENTS AND SCREENS, COLOR SELECTED FROM MANUFACTURERS STANDARD COLORS BY THE ARCHITECT, TYPICAL DOOR WIDTH TO BE 24 IN., DOORS AT ACCESSIBLE STALLS TO BE 36 IN. AND OUTSWINGING. URINAL SCREENS WALL - MOUNTED AND CANTILEVERED WITH CONTINUOUS EXTRUDED, CLEAR-ANODIZED ALUMINUM BRACKET, FULL HEIGHT OF SCREEN. PILASTER SHOES TO BE FORMED STAINLESS STEEL, MANUFACTURERS STANDARD HEIGHT TO CONCEAL FLOOR FASTENINGS, HARDWARE TO BE SATIN CHROME-PLATED, NON-FERROUS CAST METAL OR ALUMINUM AND INCLUDE GRAVITY-TYPE ADJUSTABLE PIVOT HINGES (TWO PER DOOR), NYLON BEARINGS, THUMBTURN DOOR LATCH WITH EXTERIOR EMERGENCY ACCESS FEATURE, DOOR STRIKE AND KEEPER WITH RUBBER BUMPER, AND DOOR PULL FOR OUT-SWINGING DOORS. APPROVED MANUFACTURER: HADRIAN, INC. OR APPROVED EQUAL.

2. TOILET ROOM ACCESSORIES:

- A. TOILET PAPER HOLDER- COMMERCIAL TOILET PAPER DISPENSER, SURFACE-MOUNTED, STAINLESS STEEL WITH SATIN FINISH. APPROVED MANUFACTURER: BOBRICK B-2888 OR APPROVED EQUAL
- B. SANITARY NAPKIN DISPOSAL- COMMERCIAL RESTROOM SANITARY NAPKIN DISPOSAL, SURFACE-MOUNTED, STAINLESS STEEL. APPROVED MANUFACTURER: BOBRICK B-270 OR APPROVED EQUAL.
- C. MIRRORS SHALL HAVE ONE-PIECE, TYPE 304 STAINLESS STEEL FRAME WITH INTEGRAL STIFFENERS AND BEVELED FRONT TO HOLD FRAME TIGHT AGAINST MIRROR, GALVANIZED STEEL BACK TO HAVE INTEGRAL HANGING BRACKETS FOR MOUNTING ON CONCEALED WALL HANGERS. GLASS TO BE TEMPERED. APPROVED MANUFACTURER - BOBRICK B-290 OR APPROVED EQUAL.
- D. GRAB BARS STAINLESS STEEL TYPE 304, WALL THICKNESS NOT LESS THAN 0.05 INCH, CONCEALED MOUNTING, 1-1/2" CLEARANCE BETWEEN WALL SURFACE AND INSIDE FACE OF BAR, SATIN-FINISH WITH PEENED GRIPPING SURFACE, OUTSIDE DIAMETER OF 1 1/2". APPROVED MANUFACTURER:
 - HORIZONTAL- BOBRICK B-6806.99 X 36" OR APPROVED EQUAL. HORIZONTAL- BOBRICK B-6806.99 X 42" OR APPROVED EQUAL. VERTICAL- BOBRICK B-6806.99 X 18" OR APPROVED EQUAL
- E. TOWEL HOOK SURFACE MOUNTED, STAINLESS STEEL WITH SATIN FINISH. APPROVED MANUFACTURER: - BOBRICK B-6777 OR APPROVED EQUAL.
- F. ROBE HOOK SURFACE MOUNTED, STAINLESS STEEL WITH SATIN FINISH. APPROVED MANUFACTURER: - BOBRICK B-76727 OR APPROVED EQUAL.
- 3. PLAQUE IDENTIFICATION SIGNS FOR INTERIOR APPLICATION SHALL BE STANDARD 6"x6" SIZE WITH RADIUSED CORNERS: .080" THICK BACK- PLATE LAMINATED TO FACEPLATE SURFACE: BACKPLATE BACKGROUND AS SELECTED BY ARCHITECT. TYPE SPF AS MANUFACTURED BY ASI SIGN SYSTEM OR APPROVED EQUAL.

4. MILLWORK :

- A. SOLID SURFACE COUNTERTOPS AND SILLS CORIAN SOLID-SURFACE, COLOR TO BE
- B. PLASTIC LAMINATE MILLWORK- EXPOSED CABINET EXTERIORS TO BE THERMOFUSED PLASTIC LAMINATE, COLOR: WILSONART 5 TH AVE. ELM 7966K-12 SOFT GRAIN FINISH. CONCEALED HINGES TO BE COMMERCIAL GRADE 120 DEGREE PIVOT OVERLAY STYLE, SPRING-LOADED SELF-CLOSE FEATURE AND 3-WAY ALIGNMENT ADJUSTMENTS DOOR AND DRAWER PULLS TO BE SELECTED BY THE ARCHITECT FROM THE MANUFACTURER'S STANDARD LINE. APPROVED MANUFACTURER: TMI SYSTEMS DESIGN GROUP.
 - STEVENS CABINET COMPANY OR APPROVED EQUAL



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ENGINEERING STRONG COMMUNITIES

Shelby Township

Michigan 48315

10/18/2024 **BID ISSUE** SUBMITTALS/REVISIONS

PROJECT NAME:

CLINTON TWP. FIRE STATION

SPECIFICATIONS

CHECKED BY: FEBRUARY 2024 SCALE:

AS NOTED

CLINTON TOWNSHIP



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DURING CONSTRUCTION, THE CONTRACTOR SHALL USE EXTREME CAUTION WHEN OPERATING NEAR ANY AND ALL OVERHEAD AND / OR BURIED UTILITIES.

PROJECT NO.

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ELECTRICAL SPECIFICATIONS

ELECTRICAL TRADES SPECIFICATION:

- THE GENERAL CONDITIONS AND SPECIAL CONDITIONS OF THE SPECIFICATIONS SHALL GOVERN. GENERAL
 CONDITIONS AND SPECIAL CONDITIONS REQUIREMENTS RELATED, BUT NOT LIMITED TO, RUBBISH REMOVAL,
 CUTTING AND PATCHING, OBTAINING AND PAYING FOR REQUIRED LICENSES AND PERMITS, REPLACEMENT OF
 DAMAGED OR STOLEN EQUIPMENT AND SYSTEMS, COMPLIANCE WITH ALL NATIONAL, STATE AND LOCAL
 CODES. SHALL APPLY.
- 2. THE GENERAL CONDITIONS AND SPECIAL CONDITIONS OF THE SPECIFICATIONS SHALL GOVERN. GENERAL CONDITIONS AND SPECIAL CONDITIONS REQUIRE- MENTS RELATED, BUT NOT LIMITED TO, RUBBISH REMOVAL, CUTTING AND PATCHING, OBTAINING AND PAYING FOR REQUIRED LICENSES AND PERMITS, REPLACEMENT OF DAMAGED OR STOLEN EQUIPMENT AND SYSTEMS, COMPLIANCE WITH ALL NATIONAL, STATE AND LOCAL CODES SHALL APPLY
- 3. ENTIRE INSTALLATION SHALL BE PERFORMED IN A FIRST CLASS WORK-MAN-LIKE MANNER. THE COMPLETED SYSTEMS SHALL BE FULLY OPERATIONAL; ACCEPTANCE BY THE OWNER SHALL BE A CONDITION OF THE CONTRACT. ALL WORK SHALL BE COORDINATED WITH EXISTING CONDITIONS IN ORDER TO AVOID INTERFERENCES. PRESERVE MAXIMUM HEADROOM AND AVOID OMISSIONS.
- ALL WIRING SHALL BE IN CONDUIT, RIGID OR THIN WALL AS PERMITTED BY CODE. CONDUIT SHALL BE CONCEALED WHERE POSSIBLE; WHERE EXPOSED, RUN IN STRAIGHT LINES PARALLEL AND/OR PERPENDICULAR TO BUILDING CONSTRUCTION.
- 5. ELECTRICAL CONDUITS SHALL BE RIGID GALVANIZED ASA C80.1 FOR SERVICE ENTRANCE, PANEL FEEDERS AND UNDERGROUND OR IN CONCRETE ENCASEMENT. THINWALL ASA C80.3 FOR BRANCH CIRCUITS, OUTDOOR UNDERGROUND SHALL BE PVC, SCHEDULE 40, WITH CONTINUOUS GROUND.
- 6. ALL CONDUIT FITTINGS SHALL BE GALVANIZED. ONLY GLAND TYPE, RAIN AND CONCRETE TIGHT, THREADED CONNECTORS AND COUPLINGS ARE APPROVED FOR USE WITH THIN WALL CONDUIT.
- 7. PROVIDE AND INSTALL COMPLETE EMPTY CONDUIT SYSTEM FOR TELEPHONE OUTLETS AS INDICATED ON DRAWINGS. CONDUITS SHALL BE TERMINATED AT TELEPHONE BACKBOARD WITH FIBER BUSHINGS.
- 8. CONTRACTOR SHALL INCLUDE ALL MISCELLANEOUS ITEMS REQUIRED TO COMPLETE THE WORK, INCLUDING BUT NOT LIMITED TO, THE FOLLOWING: MOVING AND RIGGING OF MATERIAL AND EQUIPMENT, ALL HANGERS, SUPPORTS, ANCHORS, EXPANSION MEANS, CONDUIT, WIRE, FITTINGS AND SLEEVES.
- 9. CONTRACTOR SHALL INCLUDE ALL TESTING, ADJUSTING & BALANCING AND COORDINATION BETWEEN TRADES. CIRCUITS SHALL BE PROPERLY BALANCED ACROSS PHASES.
- 10. PRIOR TO ORDERING EQUIPMENT, CONTRACTOR SHALL SUBMIT SHOP DRAWINGS IN QUADRUPLICATE FOR
- 11. ALL MATERIALS USED SHALL BE NEW AND BEAR THE U.L. LABEL, WHERE SUCH SERVICE AND LABEL ARE REGULARLY PROVIDED; AND BE OF THE APPROPRIATE NEMA STANDARD.
- 12. CONTRACTOR SHALL NOT SCALE DRAWINGS FOR DIMENSIONS, BUT SHALL CONTACT PROJECT ARCHITECT FOR ALL DIMENSIONAL DATA. FIELD VERIFY DIMENSIONS AND CONDITIONS PRIOR TO ROUGH IN.
- 13. ELECTRICAL CONTRACTOR SHALL PROVIDE ALL TESTS AND INSPECTIONS NECESSARY TO DETERMINE THAT ALL WIRING INSTALLED UNDER THIS SPECIFICATION IS IN SATISFACTORY CONDITION AND SHALL BE PERFORMED TO THE SATISFACTION OF THE ELECTRICAL INSPECTOR OF THE LOCAL AUTHORITY AND ALL OTHERS HAVING JURISDICTION OVER THE ELECTRICAL WORK.
- 14. ELECTRICAL CONTRACTOR SHALL DELIVER THE CERTIFICATES OF INSPECTION AND FINAL APPROVAL TO THE ARCHITECT AS A REQUIREMENT FOR FINAL PAYMENT.
- 15. ELECTRICAL CONTRACTOR SHALL GUARANTEE IN WRITING ALL WORK IN CONNECTION WITH HIS ELECTRICAL CONTRACT FOR A PERIOD OF ONE (1) YEAR FROM THE DATE OF COMPLETION OF HIS WORK AT NO COST
- 16. DISCONNECT SWITCHES SHALL BE VISIBLE BLADE, QUICK MAKE, QUICK BREAK UNIT WITH PROVISIONS FOR PADLOCKING. SWITCHES SHALL BE SQUARE D, F.P.E., G.E. OR WESTINGHOUSE, OF THE NEMA CLASS AND MATERIAL REQUIRED. LIGHTING AND RECEPTACLE PANELS SHALL BE CIRCUIT BREAKER TYPE WITH THERMAL MAGNETIC, TRIP FREE, TRIP INDICATING, INVERSE TIME COMMON TRIP \ CIRCUIT BREAKERS EQUIPPED WITH SILVER ALLOY CONTACTS AND QUICK MAKE, QUICK BREAK MECHANISM. CIRCUIT BREAKERS SHALL BE BOLTED TYPE AND RATED 10,000 A.I.C. MINIMUM (120V) 14,000 A.I.C. (277V). PANELS SHALL BE SQUARE D "NQOD" AND NEHB PANEL BOARDS, G.E. OR WESTINGHOUSE.
- 17. FURNISH AND INSTALL ALL WIRING AND CONNECTIONS TO ALL MOTORS SHOWN ON THE PLANS. FURNISH AND INSTALL DISCONNECT SWITCHES FOR ALL MOTORS. DISCONNECTING MEANS MUST COMPLY WITH THE NATIONAL ELECTRICAL CODE. ALL MANUAL AND MAGNETIC MOTOR STARTERS SHALL BE SQUARE D CLASS 8536/8538 OR EQUAL, WITH 120 VOLT OPERATION COILS WITH AUXILIARY CONTACTS WHEN REQUIRED FOR CONTROL FUNCTIONS. MOTORS 1/4 HP AND SMALLER THAT ARE NOT UNDER AUTOMATIC CONTROL SHALL BE CONTROLLED WITH SQUARE D CLASS 2510 MANUAL STARTERS OR EQUAL.
- 18. DISCONNECT SWITCHES FOR MOTORS RATED 1/3 HP AND LESS MAY BE A GENERAL USE SWITCH.
 DISCONNECT SWITCHES FOR MOTORS 1/2 HP AND LARGER SHALL BE FUSED HEAVY-DUTY SWITCHES SIMILAR
 TO SQUARE D TYPE H HEAVY DUTY LINE OR G.E. TH WITH FRONT MOUNTED HANDLE OR EQUAL. USE RAIN
 TIGHT OUTDOORS
- 19. WIRE AND CABLE SHALL BE COPPER WITH 98% CONDUCTIVITY AND SHALL MEET THE TESTS, AND STANDARDS SET FORTH BY NEMA, UL AND IPCEA. WIRE SHALL BE COPPER TYPE THHN OR XHHN.
- ELECTRIC SYSTEM GROUNDING SHALL IN ALL INSTANCES COMPLY WITH THE MINIMUM REQUIREMENTS OF TI NATIONAL ELECTRIC CODE. METAL ENCLOSURES SHALL BE BONDED TOGETHER AND GROUNDED TO THE BUILDING GROUND SYSTEM.
- 21. CONTRACTOR SHALL VERIFY EXACT LOCATION AND MOUNTING HEIGHTS OF ALL OUTLETS WITH ARCHITECT PRIOR TO INSTALLATION.
- 22. ELECTRICAL SERVICE SHALL BE AS INDICATED ON DRAWINGS.
- 23. MANUAL MOTOR STARTERS WITH OVERLOAD PROTECTION SHALL BE USED FOR FRACTIONAL HORSEPOWER MOTORS, ALLEN BRADLEY BULLETIN 600.
- 24. MINIMUM SIZE OF OUTLET BOXES SHALL BE 4" SQUARE, 1 1/2" DEEP, SUITABLY SECURED FOR THEIR PARTICULAR APPLICATION.
- 25. ALL SWITCH PLATES, RECEPTACLE PLATES, ETC., TO SATIN FINISH, STAINLESS STEEL UNLESS OTHERWISE REQUIRED BY ARCHITECT.
- 26. CONTRACTOR SHALL FURNISH AND INSTALL ALL FIXTURES AND LAMPS INCLUDING REPLACEMENTS UNTIL FINAL ACCEPTANCE OF COMPLETED WORK. FLUORESCENT LAMPS SHALL BE COOL WHITE (34 WATT POWER SAVER TYPE). FIXTURES SHALL BEAR THE U.L. LABEL AND BE INSTALLED IN FULL COMPLIANCE WITH APPLICABLE CODES. BALLASTS SHALL BE U/L ETL CMB CERTIFIED HIGH POWER FACTOR, SOUND RATED "A", THERMALLY PROTECTED. UPON COMPLETION OF WORK, ALL FIXTURES SHALL BE CLEANED AND LEFT FREE FROM ALL FOREIGN MATERIAL, DUST, ETC., WITH FUNCTIONING LAMPS. ALL PLASTIC COMPONENTS SHALL BE VIRGIN ACRYLIC. FIXTURES SHALL BE SUPPORTED FROM BUILDING STRUCTURE, NOT CEILING. FIXTURES IN FURRED SPACES SHALL BE CONNECTED BY MEANS OF FLEXIBLE CONDUIT AND AF WIRE TO OUTLET BOX INDEPENDENT OF FIXTURE.
- 27. ALL SERVICE WORK MUST CONFORM TO UTILITY COMPANY REQUIREMENTS. CONTACT UTILITY COMPANIES, VERIFY AND CORRELATE SERVICES AND PAY ALL UTILITY COMPANY CHARGES FOR EXTENSIONS, TRANSFORMERS, METERS, ETC.
- 28. PROVIDE GROUND FAULT INTERRUPTERS FOR OUTLETS IN TOILET ROOMS AND AT EXTERIOR OF BUILDING AS REQUIRED BY STATE AND LOCAL CODES.
- 29. FURNISH AND INSTALL WALL PLATES FOR ALL WIRING DEVICES AND TELEPHONE OUTLETS. IN ALL FINISHED AREAS OF THE BUILDING, PLATES SHALL BE STAINLESS STEEL .040 SATIN FINISH US 32D AS MANUFACTURED BY HUBBELL, OR APPROVED EQUAL.
- 30. GANG PLATES SHALL BE USED BY ALL GANG MOUNTED DEVICES.
- 31. NO BOXES SHALL BE LEFT UNCOVERED UNLESS SPECIFICALLY INDICATED.
 DUPLEX RECEPTACLE 20A 125V
 - FLOOR DUPLEX OUTLET
 WEATHERPROOF CONVENIENCE OUTLET
 - OUTLET 3 WIRE W/GROUND 20A-208V
 SINGLE POLE TOGGLE SWITCH 20A-120V DOUBLE POLE TOGGLE SWITCH
 - THREE-WAY TOGGLE SWITCH
 SINGLE POLE TOGGLE SWITCH WITH PILOT LIGHT

SPECIAL NATIONAL ELECTRIC CODE (NEC) NOTES:

- 1. PROPER WORKING CLEARANCE MUST BE PROVIDED AND MAINTAINED ABOUT ALL ELECTRICAL EQUIPMENT ESPECIALLY MAIN SERVICE EQUIPMENT, ALL PANELS, DISCONNECTS, TRANSFORMERS, ETC. THEY SHALL BE LOCATED IN DEDICATED SPACES. NO FOREIGN PIPES, DUCTS OR EQUIPMENT PERMITTED IN THESE DEDICATED SPACES. NEC 110-16, TABLE 110-16A AND 384-4.
- 2. STANDARD RECEPTACLES INSTALLED ON 20 AMP BRANCH CIRCUITS SHALL BE OF THE GROUNDING TYPE.
- ASSUME MINIMUM STANDARDS 20 AMP BREAKER CIRCUITS, #12 COPPER 90 DEG. C. TYPE CONDUCTORS, 1/2" CONDUIT, ETC. ANYTHING LARGER OR DIFFERENT SHALL BE SO NOTED. NEC 240-3, 240-6, TABLE 310 -16 AND CHAPTER 9 TABLE 3A.
- ALL WIRING (ELECTRICAL, TELEPHONE, ETC.) IN DUCTS, PLENUMS OF OTHER SPACE USED FOR ENVIRONMENTAL AIR SHALL BE INSTALLED IN PROPER RACEWAYS OR CABLES SPECIFICALLY LISTED FOR THE USE. NEC 300 - 22(B) AND (C).
- 5. ALL LAMPS FOR TEMPORARY LIGHTING SHALL BE PROTECTED BY A SUITABLE FIXTURE OR LAMPHOLDER WITH A GUARD. NEC 305 4(F).
- 6. ALL TEMPORARY 125 VOLT, SINGLE PHASE, 15 AND 20 AMP RECEPTACLE OUTLETS SHALL HAVE GFCI PROTECTION. NEC 305-6.
- 7. FIXTURES IN WET, DAMP OR CORROSIVE LOCATIONS OR IN DUCTS OR HOODS SHALL BE SUITABLE FOR SUCH LOCATIONS AND SO MARKED. NEC 410-4(A), (B), AND (C).
- 8. ALL FLUORESCENT FIXTURES INSTALLED INDOORS SHALL HAVE THERMAL PROTECTION INTEGRAL WITHIN THE BALLAST. NEC 410-73(E).
- 9. PROPER THERMAL OVERLOAD PROTECTION SHALL BE REQUIRED FOR ALL MOTORS. NEC 430-31.
- 10. THE DISCONNECTING MEANS FOR MOTORS SHALL BE A MOTOR-CIRCUIT SWITCH RATED IN HORSEPOWER, A CIRCUIT BREAKER, OR A MOLDED CASE SWITCH (NON-AUTOMATIC CIRCUIT INTERRUPTER) AND FOR A CORD AND PLUG-CONNECTED MOTOR, A HORSE POWER RATED ATTACHMENT PLUG AND RECEPTACLE. NEC
- 11. PROPER WIRING METHODS SHALL BE REQUIRED IN PLACES OF ASSEMBLY OF 100 OR MORE PERSONS. NON-METALLIC SHEATHED (ROMEX) CABLE SHALL NOT BE PERMITTED. NEC 518-1, 518 2 AND 518 4.
- 12. ALL BATTERY BACK-UP EXIT AND EMERGENCY LIGHTS SHALL BE FED FROM THE SAME CIRCUIT AS NORMAL LIGHTING IN THEIR RESPECTIVE AREAS AND BE CONNECTED AHEAD OF ANY LOCAL SWITCHES. NEC700-16, 700 17 AND 700 12(F). BATTERY BACK UP EXIT AND EMERGENCY LIGHTS CANNOT FEED FROM CIRCUITS OTHER THAN THE NORMAL LIGHTING IN THEIR RESPECTIVE AREAS. INCLUDE LOCK-OPEN DEVICES.
- 13. MAIN SERVICE DISCONNECTING MEANS SHALL BE PERMANENTLY MARKED TO IDENTIFY IT AS A SERVICE DISCONNECTING MEANS. NEC 230 70(B).
- 14. ALL SERVICE ENTRANCE AND/OR FEEDER CONDUCTORS NOTED SHALL BE 90 DEG. C. COPPER TYPE MINIMUM FOR PROPER CAPACITY. NEC 230 42(A), 215 2 AND TABLE 310 16.
- 15. PROPER TYPE AND SIZE OF SERVICE GROUNDING CONDUCTOR REQUIRED WITH CONNECTION TO BOTH THE METAL UNDERGROUND WATER PIPING SYSTEM AND A SUPPLEMENTAL ELECTRODE. NEC 250 23(A), 250 81, 250 83 AND TABLE 250 94.
- 16. CONTINUOUS LOADS SHALL NOT EXCEED 80% OF THE RATING OF THE BRANCH CIRCUIT. NEC 210 22(C)
- 17. LIGHTING FIXTURE SCHEDULE SEE LIGHTING PLAN FOR SCHEDULE
- 18. SMOKE DETECTORS, HEAT SENSORS AND ALARMS CEILING SMOKE DETECTORS (BY OWNER).
- 19. DUCT SMOKE DETECTORS THE DUCT DETECTORS SHALL BE SERIES DDP PHOTO ELECTRIC TYPE WITH RATE COMPENSATED / FIXED SENSITIVITY CIRCUITRY TO DETECT BOTH FAST AND SLOW BURNING FIRES. THE DETECTOR SHALL COME COMPLETE WITH SEALED HOUSING AND SAMPLING TUBES. THE DETECTORS SHALL BE 4 WIRE TYPE WITH AN ISOLATED 24VDC POWER FEED REQUIREMENT TO INSURE RELIABLE OPERATION OF THE AUXILIARY CONTROL RELAY. A POWER SUPERVISORY RELAY SHALL BE PROVIDED FOR EACH ZONE OF DUCT DETECTORS. DETECTORS SHALL BE WIRED TO THE RESPECTIVE FAN CONTROL FOR SHUT DOWN UPON ALARM. LOCATE DETECTOR IN SUPPLY DUCT NEAR EACH OF THE TWO (2) FURNACES AND WITHIN THE FURNACE ROOM. FURNISH AND INSTALL BY THE ELECTRICAL CONTRACTOR. COORDINATE WITH HVAC CONTRACTOR.

MECHANICAL SPECIFICATIONS

OVERALL PLUMBING SPECIFICATIONS:

4 SANITARY AND STORM SEWERS

- 1. COMPLY WITH STATE AND LOCAL PLUMBING CODES, OSHA AND MICHIGAN CONSTRUCTION CODE AND OBTAIN AND PAY FOR ALL PERMITS, SERVICES AND FEES.
- 2. WATER SERVICE:
 REFER TO DRAWINGS FOR WATER SERVICE BY PLUMBING CONTRACTOR.
- 3. NATURAL GAS SERVICE: REFER TO DRAWINGS FOR NATURAL GAS SERVICE BY PLUMBING CONTRACTOR.
- REFER TO DRAWINGS FOR SANITARY AND STORM SERVICE BY PLUMBING CONTRACTOR.
- 9. WATER FIFING.
 INTERIOR WATER PIPING TO BE COPPER TYPE "M" ABOVE FLOOR AND TYPE "L" BELOW FLOOR AND UNDERGROUND. INSULATE HOT AND COLD WATER ABOVE FLOOR WITH 1" FIBERGLASS WITH FRJ JACKET.
 JOINTS BELOW FLOOR ARE NOT PERMITTED.
- 6. SANITARY PIPING:
 SERVICE WEIGHT CAST IRON (OR SCHEDULE 40 PVC AS PERMITTED BY CODE) TO FIVE FOOT OUTSIDE
 OF BUILDING BY BUILDING CONTRACTOR
- 7. GENERAL PLUMBING FIXTURE SCHEDULE:
 FURNISH STOPS FOR EACH FIXTURE. REFER TO MICHIGAN CONSTRUCTION CODE FOR SPECIAL MOUNTING
 HEIGHTS OF FIXTURES FOR USE BY PHYSICALLY HANDICAPPED PERSONS.
- ON COMPLETION OF INSTALLING THE WATER SYSTEM, THE PLUMBING CONTRACTOR SHALL HAVE BACTERIOLOGICAL SAMPLES OF THE WATER FROM THE SYSTEM TESTED BY THE MICHIGAN DEPARTMENT OF HEALTH. IF WATER IS DETERMINED TO BE UNSAFE, THE CONTRACTOR SHALL CHLORINATE THE SYSTEM USING ACCEPTABLE METHODS AND FLUSH UNTIL THE SYSTEM IS PROVEN SAFE BY FURTHER TESTING. VERIFY NEED FOR CHLORINATION WITH LOCAL INSPECTOR.
- GUARANTEE:
 THE PLUMBING CONTRACTOR SHALL PROVIDE A WRITTEN GUARANTEE OF THE ENTIRE SYSTEM FOR A PERIOD OF (1) ONE YEAR FROM DATE OF FINAL ACCEPTANCE.
- 10. ROOF SUMP SHALL BE GALVANIZED CAST IRON DOME. PROVIDE UNDER DECK CLAMP, SUMP RECEIVER AND EXTENSION. PROVIDE NO HUB ADAPTERS WHERE REQUIRED. CONTRACTOR TO PROVIDE EXTENSION TO MATCH ROOF INSULATION EQUAL TO J.R. SMITH 1010 ERC6 OR MIFAB R1200-EU-12.
- 11. OVERFLOW SUMPS EQUAL TO JR SMITH 1070 ERC6-CIS OR MIFAB R1200 EU 12 W.
- 12. CLEANOUTS ON 100 FT. INTERVALS (50' FOR 4" OR SMALLER) FOR SANITARY AND STORM PIPING, AT END BRANCHES, STACKS, AND AT 90 DEGREE BENDS. LOCATE IN WALL WHERE POSSIBLE.
- 13. PROVIDE BACKFLOW PREVENTERS WHERE REQUIRED BY LOCAL BOARD OF HEALTH OR PLUMBING CODES.

HEATING AND AIR CONDITIONING SPECIFICATIONS:

- 1 GENERAL
- COMPLY WITH MICHIGAN CONSTRUCTION CODE, OSHA, AND LOCAL CODES, AND OBTAIN AND PAY FOR ALL PERMITS AND FEES.
- 2. INSTALLATION:
 INSTALL ALL EQUIPMENT IN STRICT ACCORD WITH MANUFACTURER'S INSTRUCTIONS. REFER TO EQUIPMENT SCHEDULES FOR ADDITIONAL INFORMATION.
- GAS PIPING:
 BLACK STEEL, SCHEDULE 40. INCLUDE SHUT OFF VALVES AT EACH PIECE OF EQUIPMENT REQUIRING GAS.
 ALL GAS PIPING 2 1/2" AND ABOVE SHALL BE WELDED CONSTRUCTION.
- WIRING: ALL CONTROL WIRING BY THIS CONTRACTOR, POWER WIRING BY ELECTRICAL CONTRACTOR, ALL CONDUIT WORK BY ELECTRICAL CONTRACTOR.
- 5. DUCTS:

 GALVANIZED STEEL DUCTWORK (ABOVE FLOOR) 0" TO 12" 26 GAUGE, 13" TO 30" 24 GAUGE, 31" TO 40" 22
 GAUGE, 44" AND ABOVE 20 GAUGE. WHERE SQUARE TURNS ARE NECESSARY IN RETURN AIR DUCTWORK,
 TURNING VANES SHALL BE USED. ALL DUCTS BELOW CONCRETE FLOORS SHALL BE PEABODY SPUNSTRAND
 FIBERGLASS AIRDUCT DISTRIBUTED BY MICHIGAN AIR PRODUCTS OF ROYAL OAK, MI. OR SOLID PVC 441 PIPE,
 WITH PVC FITTINGS AND CONNECTIONS, BY AIR DISTRIBUTION COMPANY OF GARY INDIANA, DISTRIBUTED BY

MANUFACTURER'S RE-COMMENDATIONS. ALL DUCTWORK ABOVE FLOOR TO BE INSULATED INTERNALLY

BEHLER - YOUNG OF SAGINAW, MI. ALL CONNECTIONS SHALL BE MADE IN ACCORDANCE WITH

WITH 1/2" FIBERGLASS AERO FLEX. DUCT SIZES SHOWN TO BE INSIDE OF INSULATION.

6. FLUES: METALBESTOS OR EQUAL. CLASS "B".

BY ELECTRICAL CONTRACTOR.

- 7. FIRE DAMPERS:
 ASTM E-152 FOR ONE HOUR RATING. SUBMIT SHOP DRAWINGS FOR APPROVAL.
- THERMOSTATS (ELECTRIC):

 KEY OPERATED WITH INDICATING THERMOMETER. TO CONTROL BURNER ON HEATING CYCLE AND
 CONDENSER ON COOLING. INSTALL HEATING-COOLING CHANGE-OVER SWITCH. CONTROL WIRING IN
 RETURN AIR PLENUMS SHALL BE RUN IN METALLIC CONDUIT OR FIRE RATED CABLE. ALL CONDUIT WORK
- 9. EXHAUST FANS :
- REFER TO SCHEDULE OF EXHAUST FANS ON MECHANICAL PLANS.

 10. FURNACES, AIR HANDLER UNITS AND CONDENSING UNITS: REFER TO SCHEDULE OF HVAC EQUIPMENT ON MECHANICAL PLANS. ON OFF SUB BASE ACCESSORY, NON COMBUSTIBLE COMPONENTS AND MATCHED COOLING COILS AND CONDENSING UNITS.
- 11. CONDENSING UNITS SHALL BE COMPLETE WITH TIME GUARD DEVICE TO PREVENT SHORT CYCLING, INDOOR FAN RELAY CRANKCASE HEATER AND RELAY HIGH AND LOW PRESSURE SWITCHES, SINGLE-SPEED CONDENSER AIR FAN, TWO-POLE CONTACTOR, FULLY CHARGED TUBING PACKAGES.
- 12. REFRIGERANT PIPING:
 ALL REFRIGERANT PIPING, BOTH SUCTION AND LIQUID LINES, SHALL BE TYPE "L" HARD DRAWN COPPER REFRIGERATION TUBE, SEALED WITH WROUGHT COPPER SWEAT FITTINGS, SILVER SOLDERING, TEST AT 300 PSI. INSULATE WITH 1/2" ARMAFLEX.
- 13. LOUVERS, DIFFUSERS AND REGISTERS (HVAC):
 REFER TO SCHEDULE AND NOTES ON MECHANICAL PLAN.
- 14. TESTING, ADJUSTING, AND BALANCING: CONTRACTOR WILL EMPLOY AND PAY FOR SERVICES OF AN INDEPENDENT FIRM TO PERFORM TESTING, ADJUSTING AND BALANCING.
- GUARANTEE :
- CONTRACTOR SHALL GUARANTEE ENTIRE SYSTEM FOR A PERIOD OF (1) YEAR FROM DATE OF FINAL ACCEPT



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Michigan 48315

10/18/2024 BID ISSUE

DATE SUBMITTALS/REVISIONS

PROJECT NAME:

STATION RENOVATIONS

HEET TITLE:

SPECIFICATIONS

:HENT:


PRELIMINARY CONSTRUCTION RECORD

CHECKED BY:

FEBRUARY 2024

CLINTON TOWNSHIP



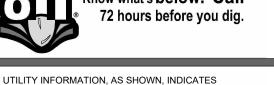

FACILITIES ONLY, AS DISCLOSED BY RECORDS PROVIDED TO THIS FIRM FROM THE VARIOUS UTILITY COMPANIES. NO GUARANTEE IS GIVEN OR IMPLIED AS TO THE COMPLETENESS OR ACCURACY THEREOF.

PRIOR TO CONSTRUCTION, ALL LOCATIONS AND DEPTHS OF EXISTING OVERHEAD AND UNDERGROUND UTILITIES (IN CONFLICT WITH THE CONSTRUCTION OF THESE

APPROXIMATE LOCATIONS AND TYPES OF EXISTING

(IN CONFLICT WITH THE CONSTRUCTION OF THESE PROPOSED IMPROVEMENTS) SHALL BE VERIFIED IN THE FIELD. DURING THE CONSTRUCTION, THE CONTRACTOR SHALL PROTECT AND SUPPORT ALL UTILITIES THAT ARE ENCOUNTERD. (ALL COSTS FOR UTILITY LOCATION VERIFICATION, SUPPORT AND PROTECTION SHALL BE INCLUDED IN THE PROPOSED PAY ITEM CONFLICTING WITH THAT UTILITY).

DURING CONSTRUCTION, THE CONTRACTOR SHALL USE EXTREME CAUTION WHEN OPERATING NEAR ANY AND ALL OVERHEAD AND / OR BURIED UTILITIES.


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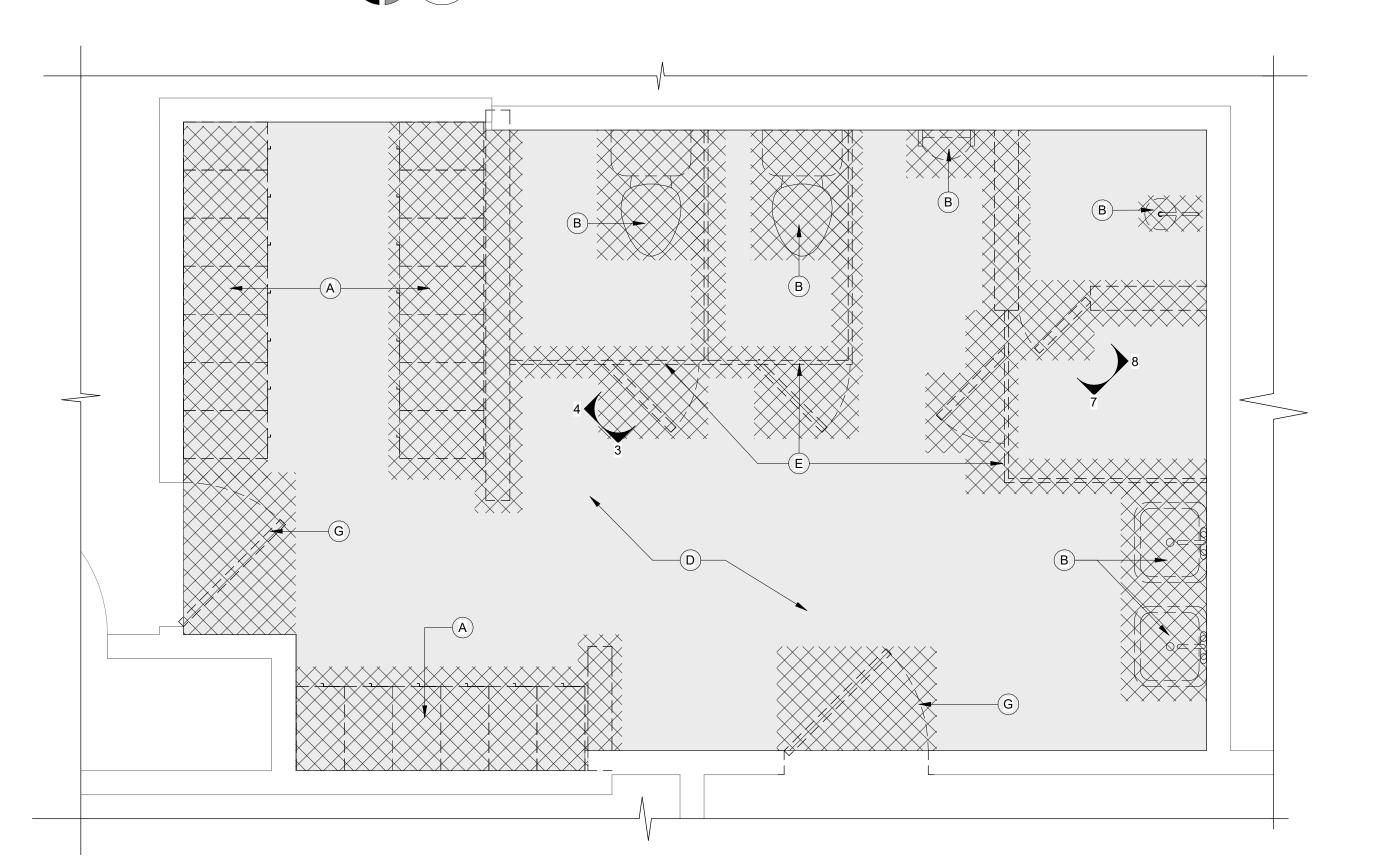
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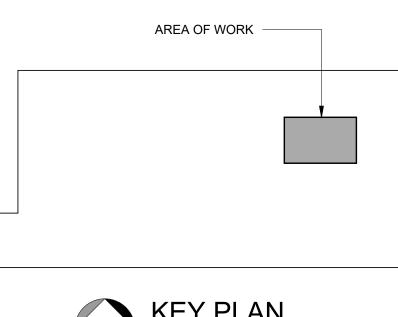
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GENERAL NOTES :

1. VERIFY ALL EXISTING DIMENSION IN FIELD. NOTIFY ARCHITECT OF ANY DISCREPANCY.

DEMOLITION PLAN KEYNOTES :

- REMOVE LOCKERS AND 4" CONCRETE/TILE BASE
- REMOVE PLUMBING FIXTURES & ACCESSORIES COMPLETE. CONTRACTOR TO COORDINATE WITH OWNER ALTERNATIVE PLUMBING FACILTIES DURING CONSTRUCTION IN STATIONS 2 & 3.
- DEMOLISH EXISTING TILE FLOOR, BASE AND 49" HIGH WAINSCOT, PREPARE SURFACES FOR NEW TILE.
- REMOVE EXISTING PARTITIONS. PREPARE DAMAGED SURFACES AS NECESSARY FOR NEW WORK

HARDWARE AND RETURN TO OWNER

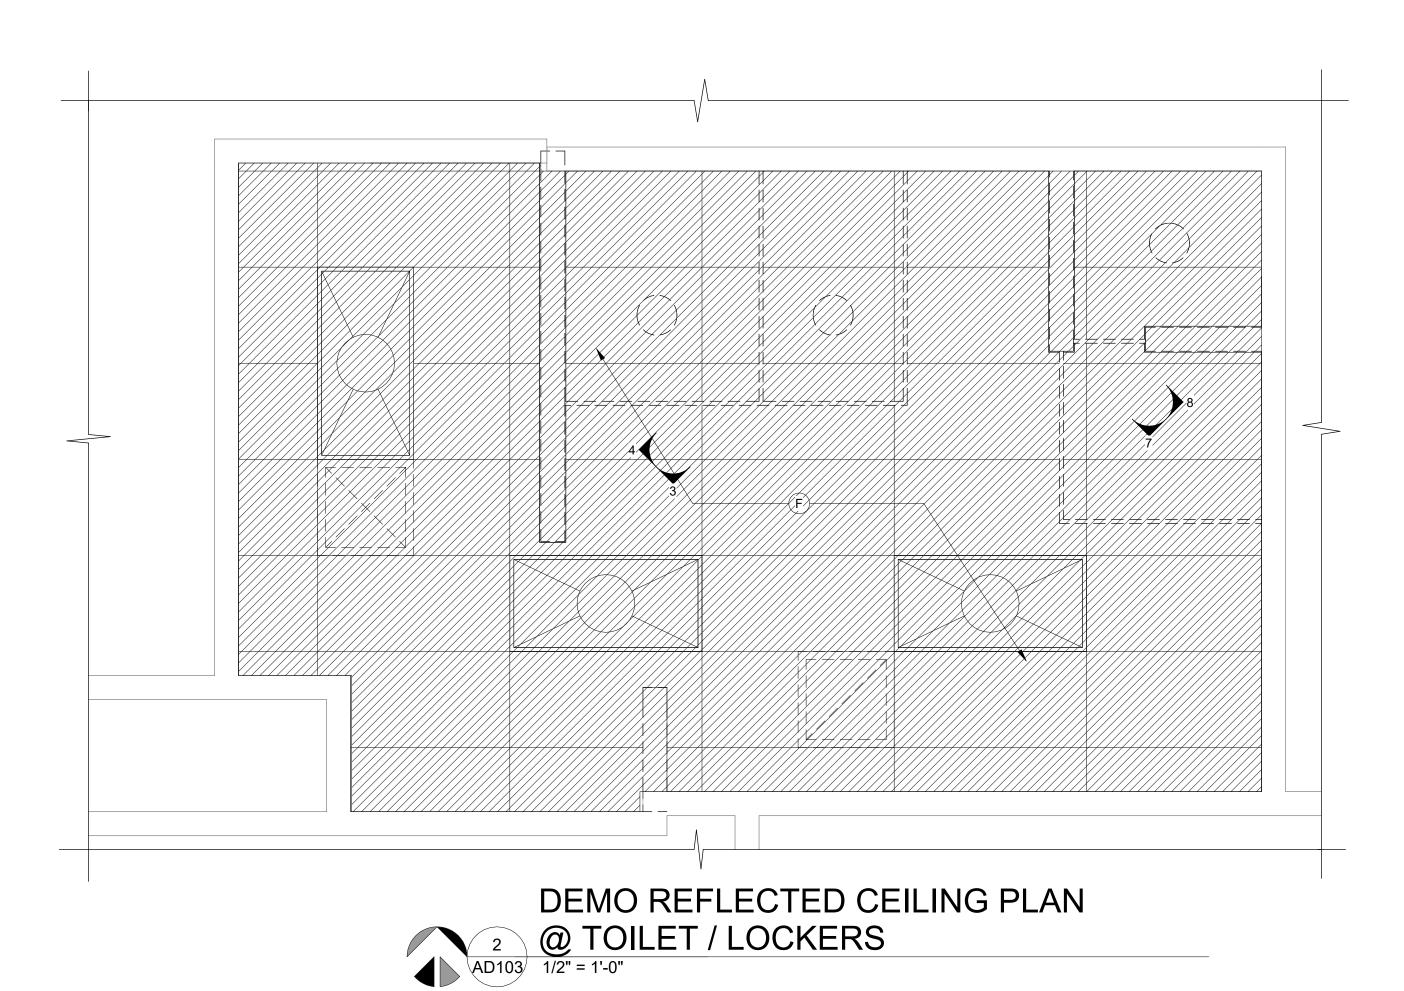- REMOVE CEILING, LIGHTS AND MECHANICAL EQUIPTMENT COMPLETE
- REMOVE EXISTING DOOR, PREPARE FRAME FOR NEW DOOR. EXIST. WOOD TRANSOM PANEL TO REMAIN (PAINT). SALVAGE DOOR

DEMOLITION PLAN LEGEND :

EXISTING WALL TO BE REMOVED (SEE DEMO PLAN)

EXISTING WALL TO REMAIN



EXISTING FLOOR FINISH AND CEILING TO BE REMOVED

BID ALTERNATE: PROVIDE BID ALTERNATE FOR PORTABLE RESTROOM AND SHOWER UNIT FOR USE DURING PLUMBING CONSTRUCTION AS NECESSARY. CONTRACTOR TO COORDINATE USE OF FACILITES FOR OWNER.




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CLINTON TWP. FIRE

STATION RENOVATIONS

FIRE STATION No. 2 & 3 DEMOLITION **PLANS** -TOILET/LOCKERS **ROOM**

CLINTON TOWNSHIP

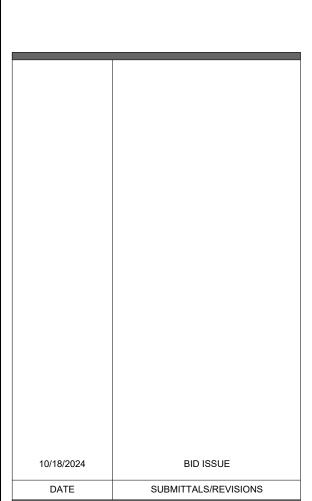OCTOBER 2024

AS NOTED



UTILITY INFORMATION, AS SHOWN, INDICATES APPROXIMATE LOCATIONS AND TYPES OF EXISTING FACILITIES ONLY, AS DISCLOSED BY RECORDS PROVIDED

TO THIS FIRM FROM THE VARIOUS UTILITY COMPANIES. NO GUARANTEE IS GIVEN OR IMPLIED AS TO THE COMPLETENESS OR ACCURACY THEREOF. PRIOR TO CONSTRUCTION, ALL LOCATIONS AND DEPTHS OF EXISTING OVERHEAD AND UNDERGROUND UTILITIES (IN CONFLICT WITH THE CONSTRUCTION OF THESE PROPOSED IMPROVEMENTS) SHALL BE VERIFIED IN THE


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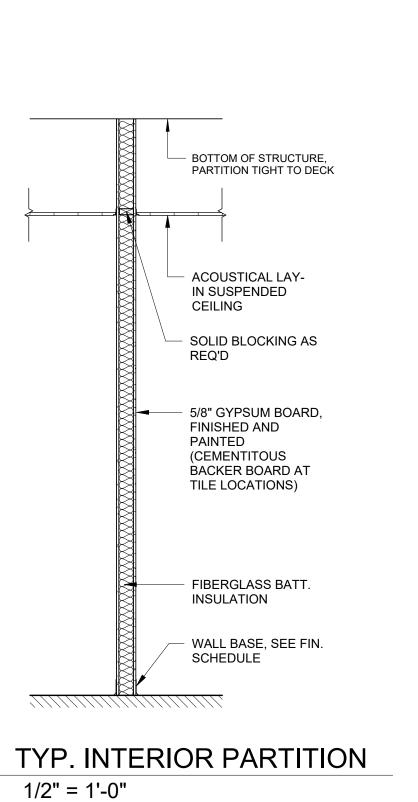
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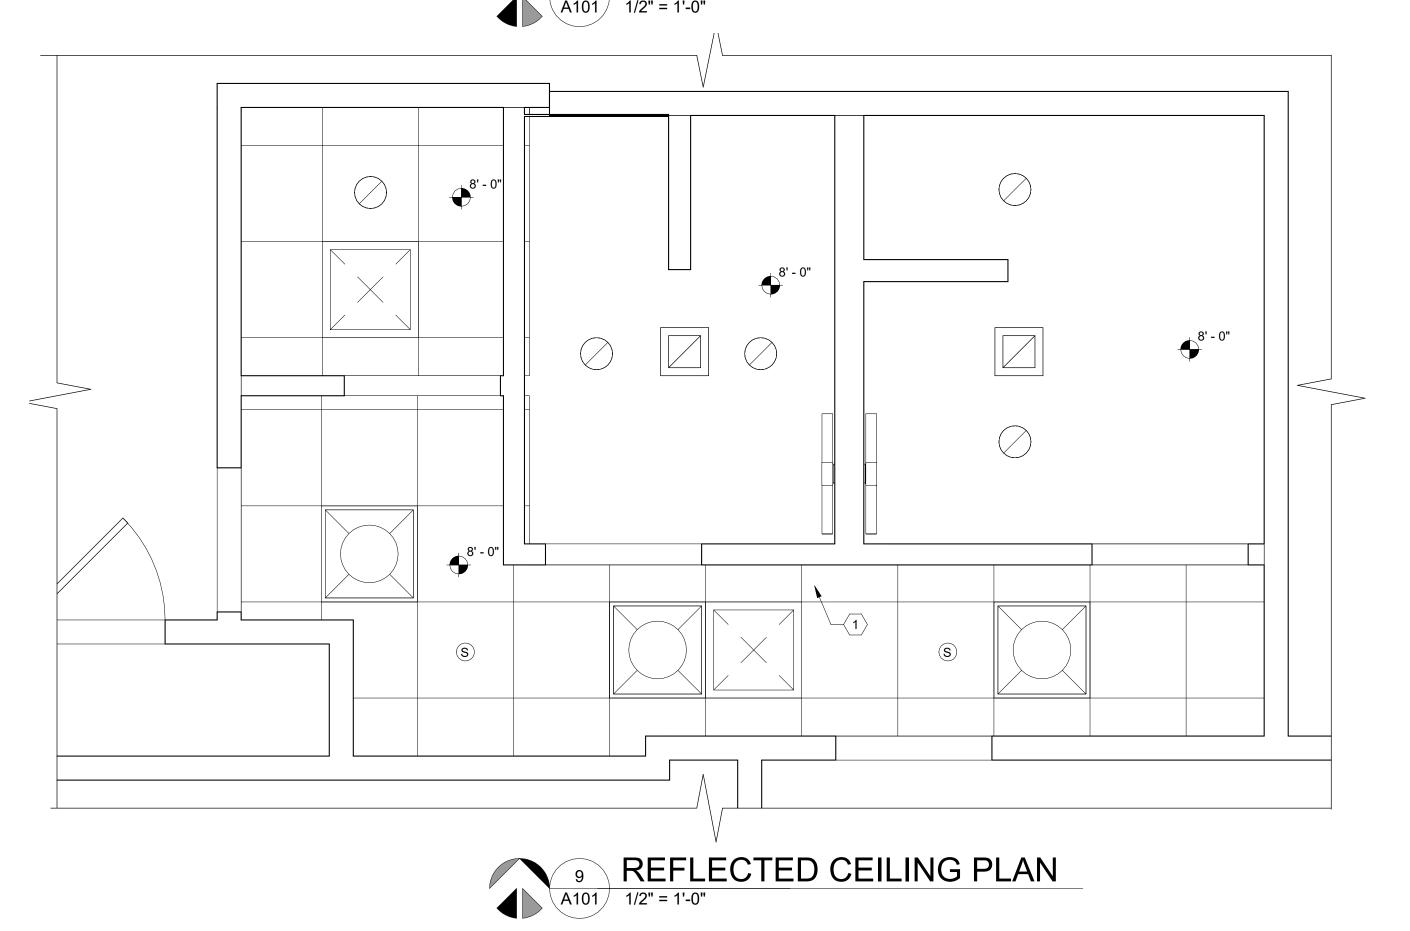
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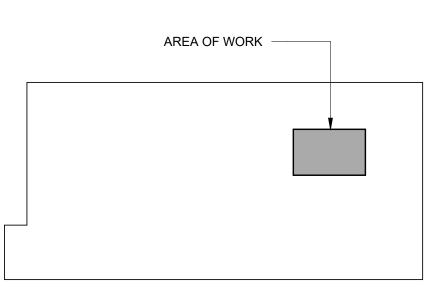
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A101







PARTITION TYPES

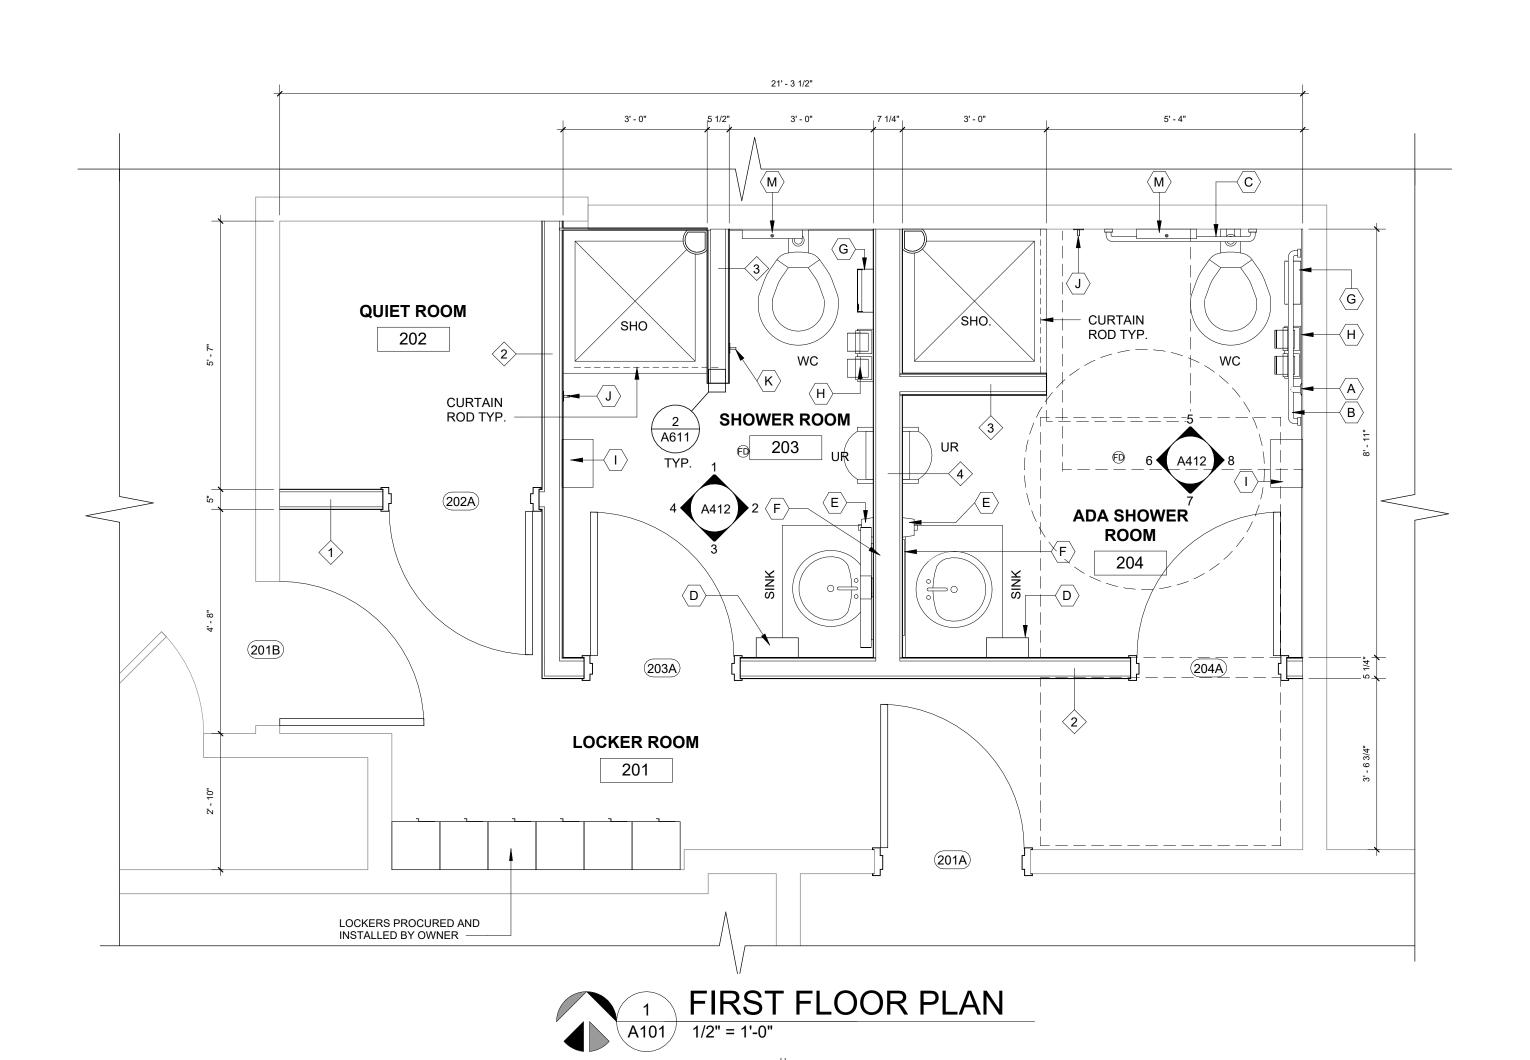5/8" GYP. BOARD, 3 5/8" METAL STUDS @ 16" O.C. W/
SOUND INSULATION, 5/8" GYP. BOARD, SEE ROOM FIN.
SHCEDULE

1/4" PORCELAIN CERAMIC TILE, 5/8" GREEM BOARD,
3 5/8" METAL STUDS @ 16" O.C. W/ SOUND INSULATION,
5/8" GYP. BOARD (SEE ROOM FIN. SCHEDULE)

1/4" PORCELAIN CERAMIC TILE, 5/8" GREEM BOARD,
3 5/8" METAL STUDS @ 16" O.C. W/ SOUND INSULATION, 5/8"
GREEN BOARD, 1/4" PORCELAIN CERAMIC TILE (SEE RM.
FIN.SCHEDULE)

1/4" PORCELAIN CERAMIC TILE, 5/8" GREEM BOARD, 6" METAL STUDS @ 16" O.C. W/ SOUND INSULATION, 5/8" GREEN BOARD, 1/4" PORCELAIN CERAMIC TILE (SEE RM.

TOILET ACCESSORIES LEGEND:

A 18" VERTICAL GRAB BAR

FIN. SCHEDULE)

TO VERTIFICATE STATE BATTE

B 42" HORIZONTAL GRAB BAR

C 36" HORIZONTAL GRAB BAR

D PAPER TOWEL DISPENSER - OWNER PROVIDED, CONTRACTOR INSTALL

E SOAP DISPENSER

F MIRROR

G SANITARY NAPKIN DISPOSAL

H TOILET PAPER HOLDER

TRASH RECEPTACLE- OWNER PROVIDE, OWNER INSTALLED

J TOWEL HOOK

K ROBE HOOK

L SHOWER SOAP HOLDER

M SET COVER DISPENSER

CEILING LEGEND:

24" X 24" SUSP. ACOUSTICAL LAY-IN CEILING

GYPSUM BOARD CEILING, PAINTED

2'x4' LED LIGHT RECESSED FIXTURE

2'x4' LED (NIGHT LIGHT) W/ BATTERY BACK-UP
2'x2' LED LIGHT RECESSED FIXTURE

RETURN AIR GRILLE

EXIT LIGHT - CEILING MOUNTED -ARROWS AS INDICATED ON PLAN (SHADED AREA INDICATES FACE(S)

OF FIXTURE), SEE ELECTRICAL PLÁN

CEILING DIFFUSER

REFLECTED CEILING NOTES

1 ADD SHUT OFF VALVES FOR NEW SHOWERS




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PROJECT NAME:

CLINTON TWP. FIRE STATION RENOVATIONS

HEET TITLE:

FIRE STATION 2 & 3
FLOOR AND
REFLECTED
CEILING PLANS @
TOILET / LOCKER

CLINTON TOWNSHIP

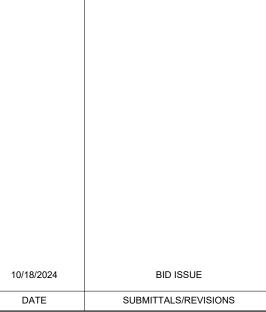PRELIMINARY CONSTRUCTION RECORD

DRAWN BY: CHECKED BY: DATE:
ARD MM OCTOBER 2024

SCALE:

AS NOTED



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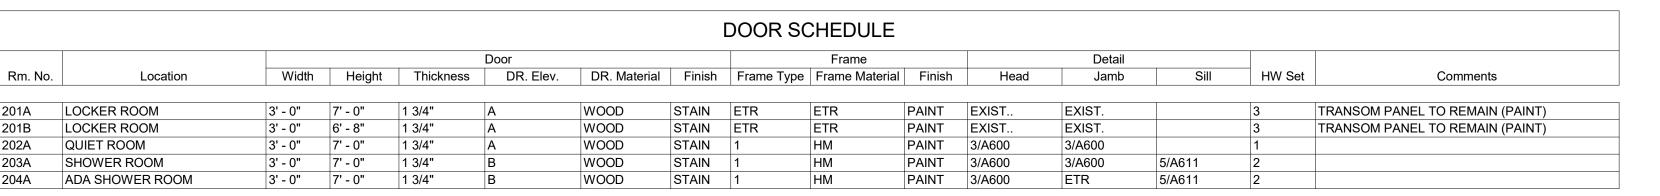
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INCLUDED IN THE PROPOSED PAY ITEM CONFLICTING WITH

DURING CONSTRUCTION, THE CONTRACTOR SHALL USE EXTREME CAUTION WHEN OPERATING NEAR ANY AND ALL OVERHEAD AND / OR BURIED UTILITIES.


PROJECT NO.

0242-0451

A101



						ROC	M FINIS	SH SCHI	EDULE					
							W A	LLS				CEILINGS		
RM. NUMBER	LOCATION	FLOOR FIN.	BASE FIN.	N. MATERIAL	N. FINISH	E. MATERIAL	E. FINISH	S. MATERIAL	S. FINISH	W. MATERIAL	W. FINISH	CEILING MATERIAL	CEILING FIN.	COMMENTS
						1						-		
01	LOCKER ROOM	LVT	RB	GYP	PT-1	ETR	PT-1	ETR	PT-1	ETR	PT-1	ACT	-	
02	QUIET ROOM	LVT	RB	ETR	PT-1	GYP	PT-1	GYP	PT-1	ETR	PT-1	ACT	-	
03	SHOWER ROOM	СТ	СТ	ETR	PT-1/CT	GYP	PT-1/CT	GYP	PT	GYP	PT-1/CT	GYP	PT-2	CERAMIC TILE FROM FINISH FLOOR UP TO 5'- 4"
04	ADA SHOWER ROOM	СТ	СТ	ETR	PT-1/CT	GYP	PT-1/CT	GYP	PT	GYP	PT-1/CT	GYP	PT-2	CERAMIC TILE FROM FINISH FLOOR UP TO 5'- 4"

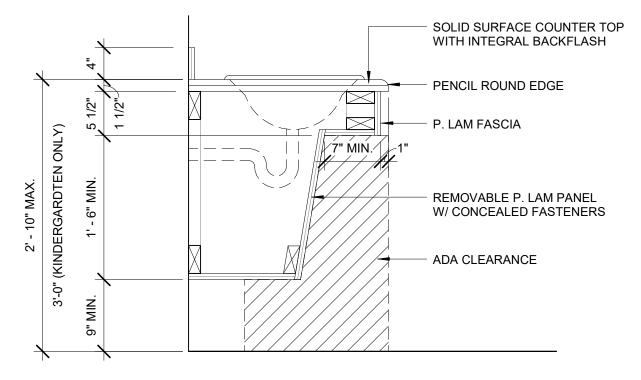

9 TYP. LAVATORY SECTION DETAIL A412 1" = 1'-0"

INTER. ELEV. C @ ADA SHOWER

∖A611∕ TYP.

8 INTER. ELEV. D @ ADA SHOWER RM.
1/2" = 1'-0"

GYP. BD., SEE-RM. FIN. SCH.


SEE DOOR-

SCHEDULE

WALL TILE, SE RM. FIN. SCH.

CLNG. LINE

A412 1/2" = 1'-0"

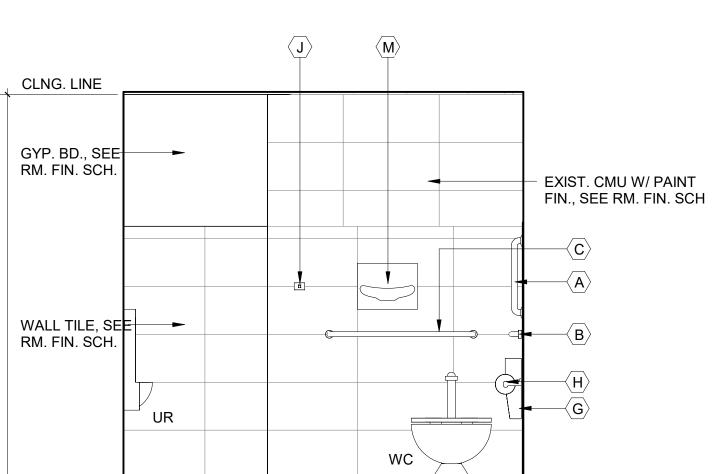

(G) SANITARY NAPKIN DISPOSAL

TRASH RECEPTACLE- OWNER

PROVIDE, OWNER INSTALLED

⟨H⟩ TOILET PAPER HOLDER

(L) SHOWER SOAP HOLDER

M SEAT COVER DISPENSER

⟨K⟩ ROBE HOOK

VCT

CT

RB

PT - 1

PT - 2


PT - 3

GB

ACT


ETR

5 INTER. ELEV. A @ ADA SHOWER RM. 1/2" = 1'-0"

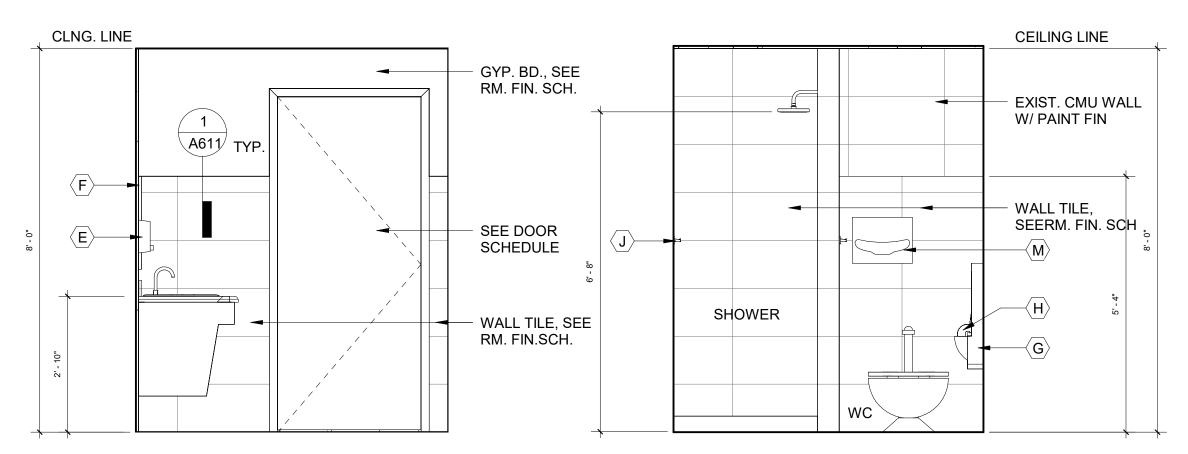

A412 1/2" = 1'-0"



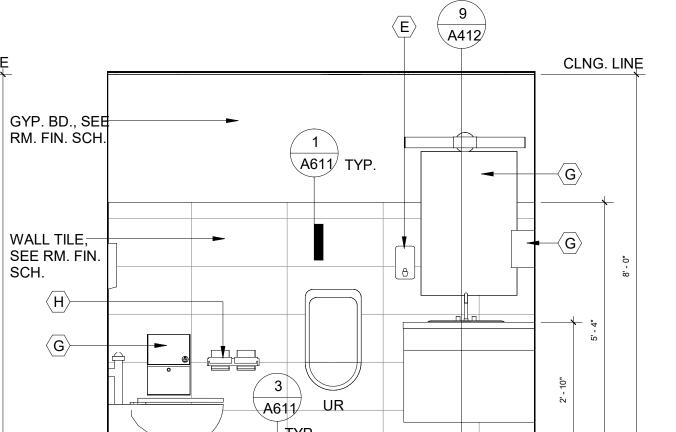

2 INTER ELEV. B @ SHOWER RM. 1/2" = 1'-0"


WALL TILE SEE RM. FIN. SCH. $\langle G \rangle$

CLNG. LINE

PROJECT NO. 0242-0451

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(A) 18" VERTICAL GRAB BAR

SOAP DISPENSER

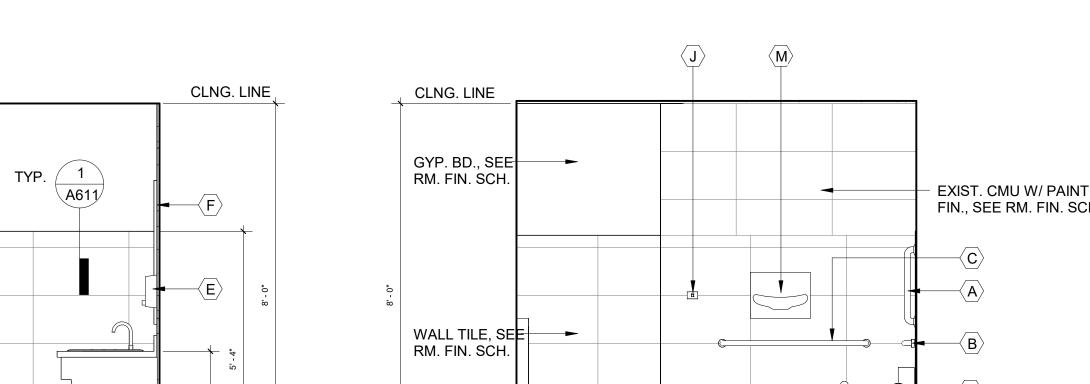MIRROR

EXIST. CMU W/ PAINT FIN., SEE RM. FIN. SCH.


(B) 42" HORIZONTAL GRAB BAR

36" HORIZONTAL GRAB BAR

PROVIDED, CONTRACTOR INSTALL


TOILET ACCESSORIES LEGEND :

PAPER TOWEL DISPENSER - OWNER (J) TOWEL HOOK

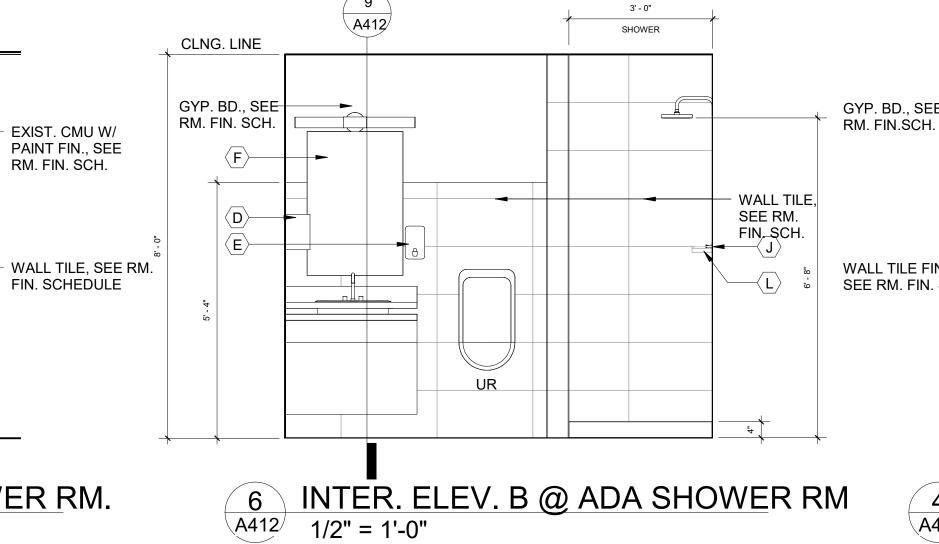

WALL TILE FIN SEE RM. FIN. SCH. WC `



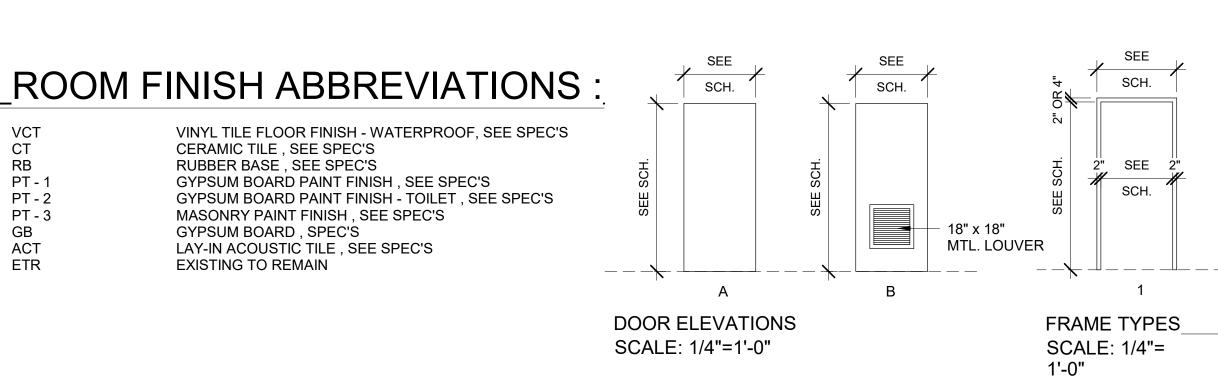

PROJECT NAME: **CLINTON TWP. FIRE STATION RENOVATIONS**

BID ISSUE SUBMITTALS/REVISIONS

ANDERSON, ECKSTEIN AND

WESTRICK, INC.

CIVIL ENGINEERS SURVEYORS ARCHITECTS

Fax 586 726 8780

51301 Schoenherr Road Phone 586 726 1234

ENGINEERING STRONG COMMUNITIES


Michigan 48315 www.aewinc.com

Shelby Township

10/18/2024

FIRE STATION 2 & 3-**INTERIOR ELEVATIONS AND ROOM FINISH** SCHEDULE

CLINTON TOWNSHIP

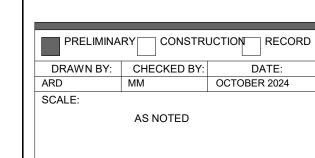




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SHEET NO.



CERAMIC TILE, SEE SPEC'S

RUBBER BASE, SEE SPEC'S

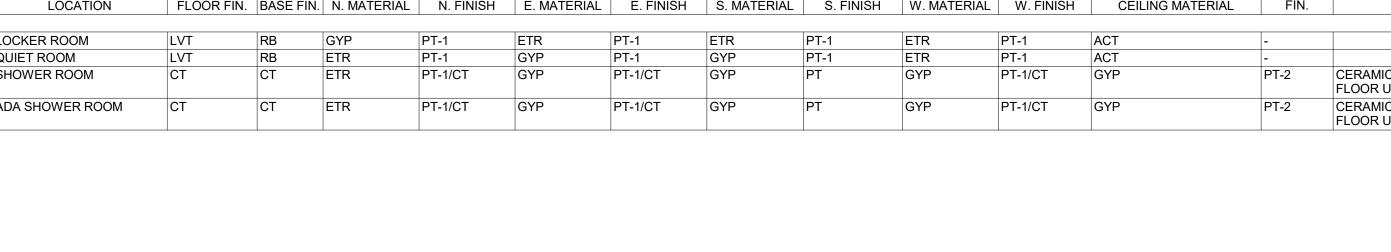GYPSUM BOARD , SPEC'S


EXISTING TO REMAIN

GYPSUM BOARD PAINT FINISH, SEE SPEC'S

MASONRY PAINT FINISH, SEE SPEC'S

LAY-IN ACOUSTIC TILE, SEE SPEC'S

GYPSUM BOARD PAINT FINISH - TOILET, SEE SPEC'S

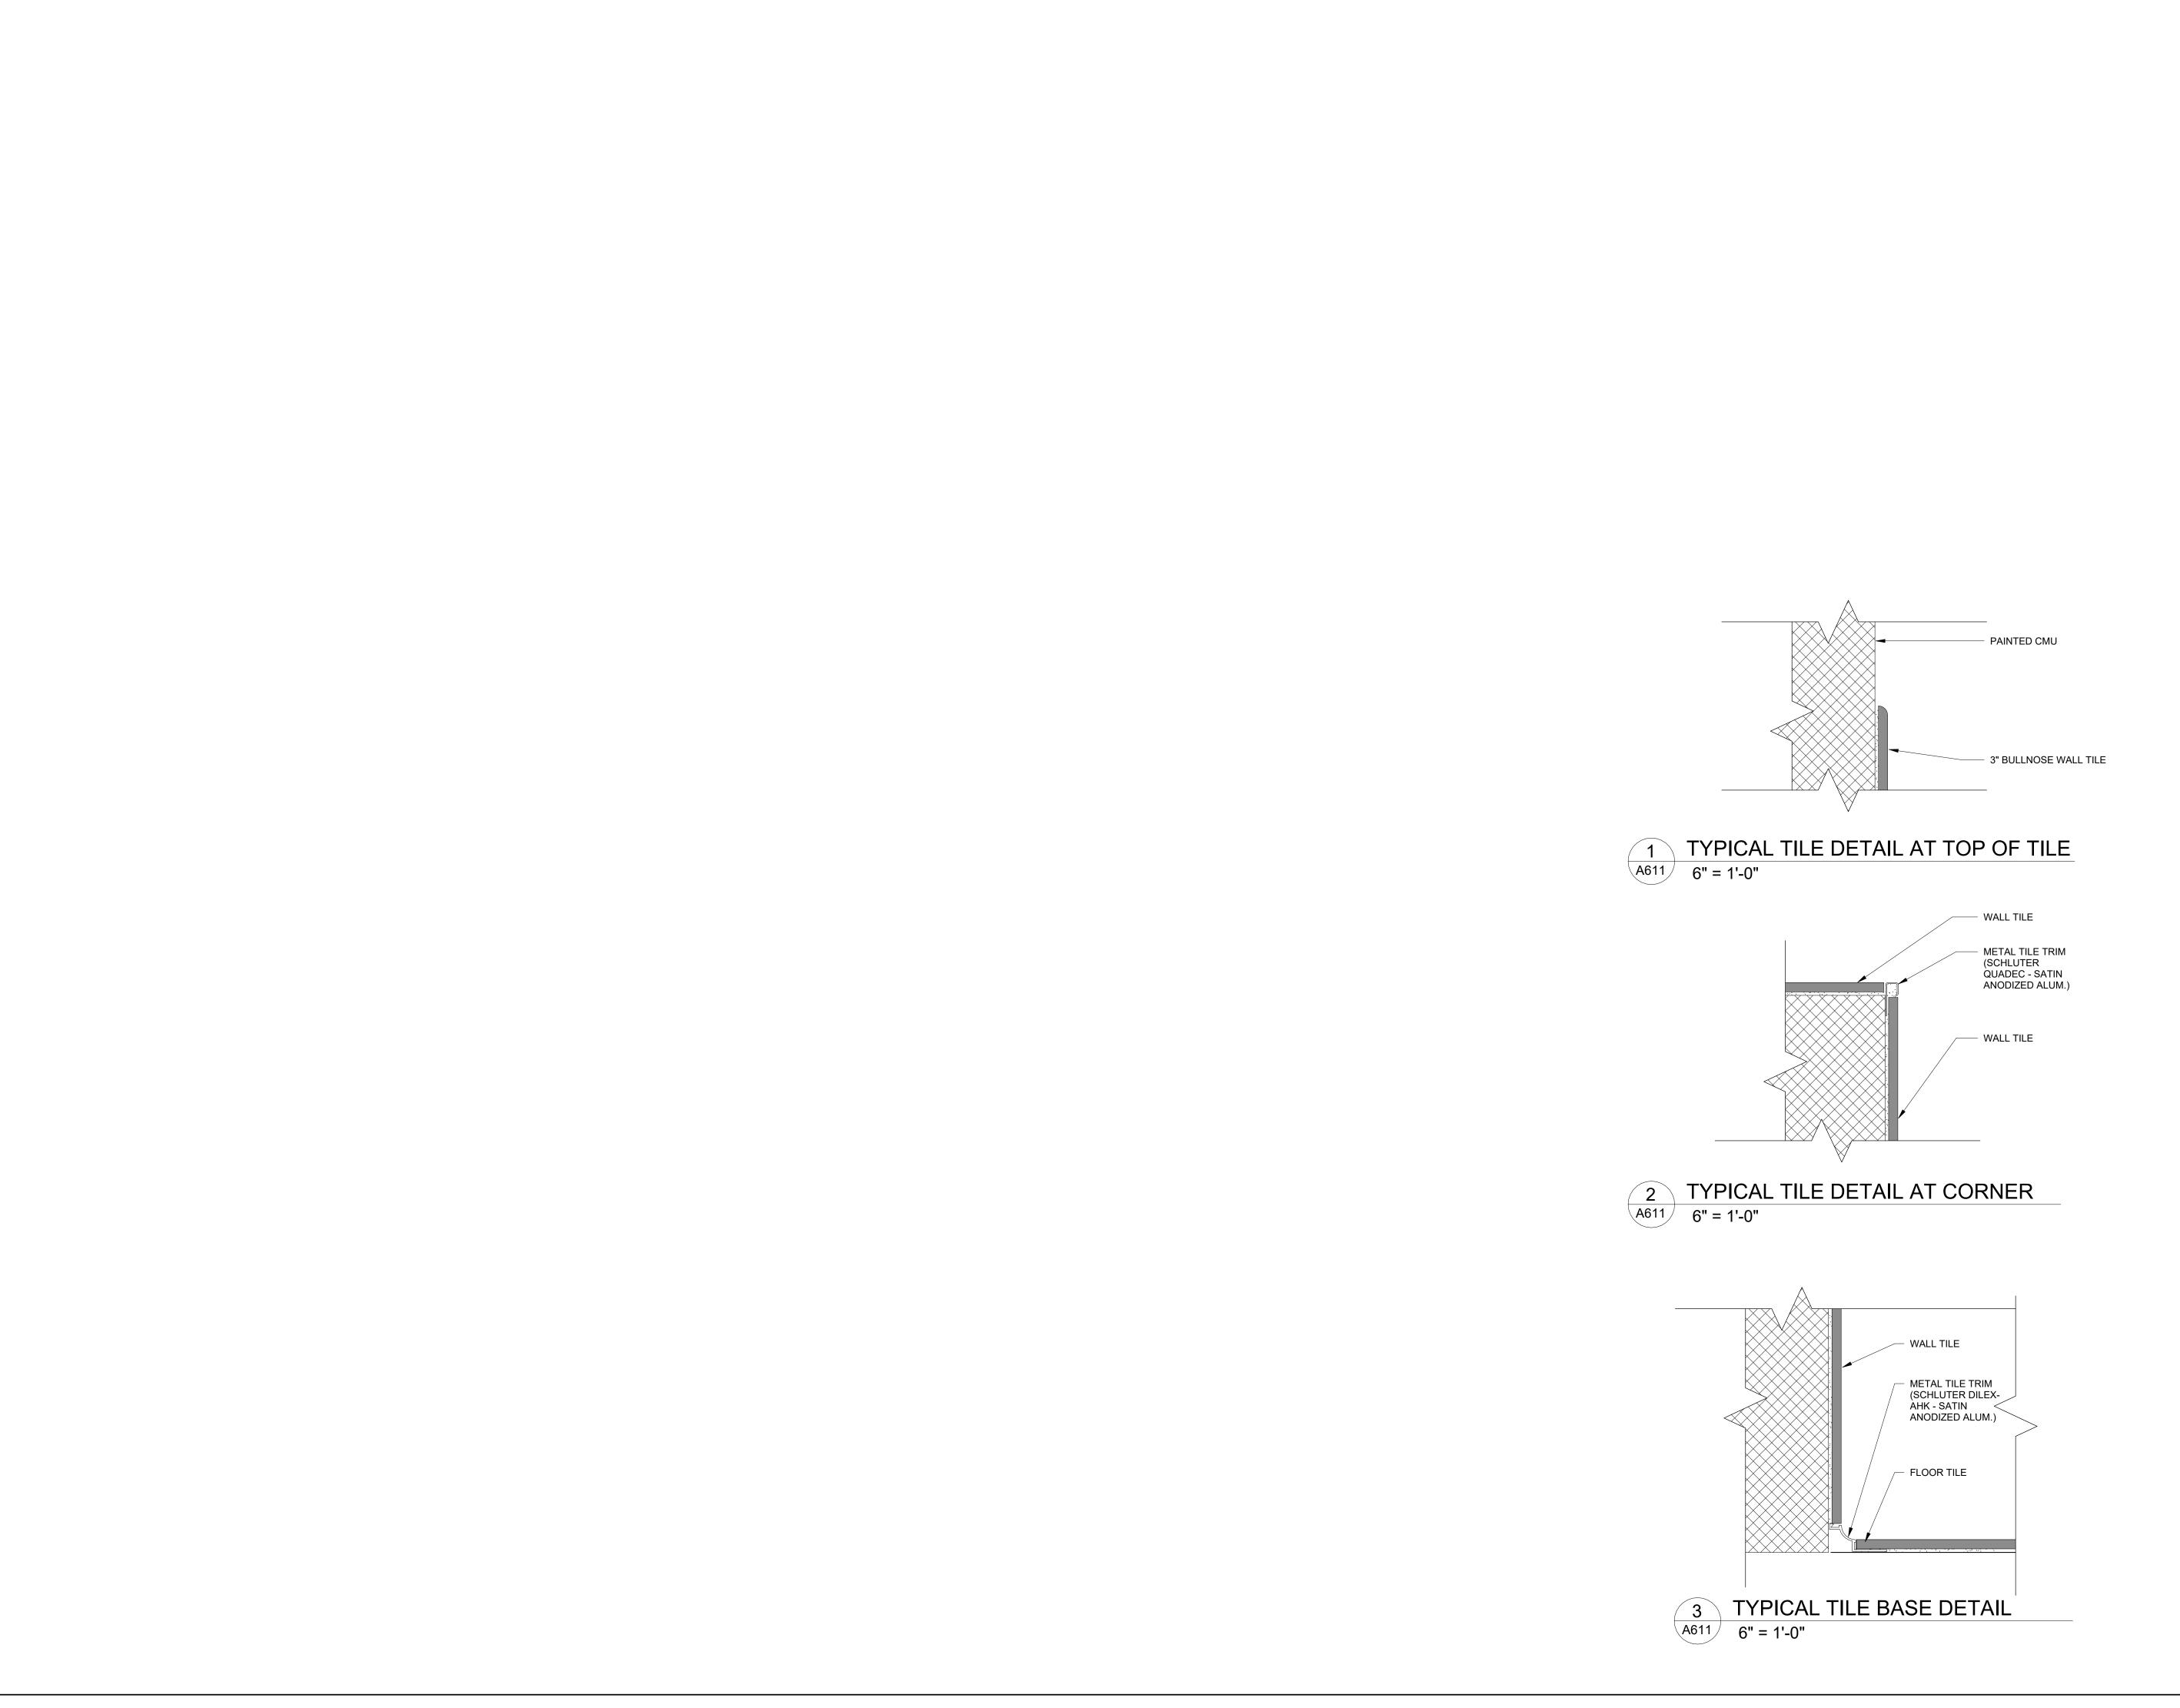




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SUBMITTALS/REVISIONS

CLINTON TWP. FIRE STATION RENOVATIONS

PROJECT NAME:

ROOM FINISH SCHEDULE

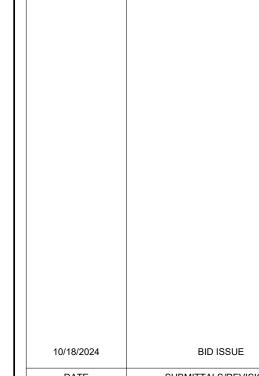CLINTON TOWNSHIP

PRELIMINARY CONSTRUCTION RECORD DRAWN BY: CHECKED BY: DATE:

Checker OCTOBER 2024 SCALE: AS NOTED



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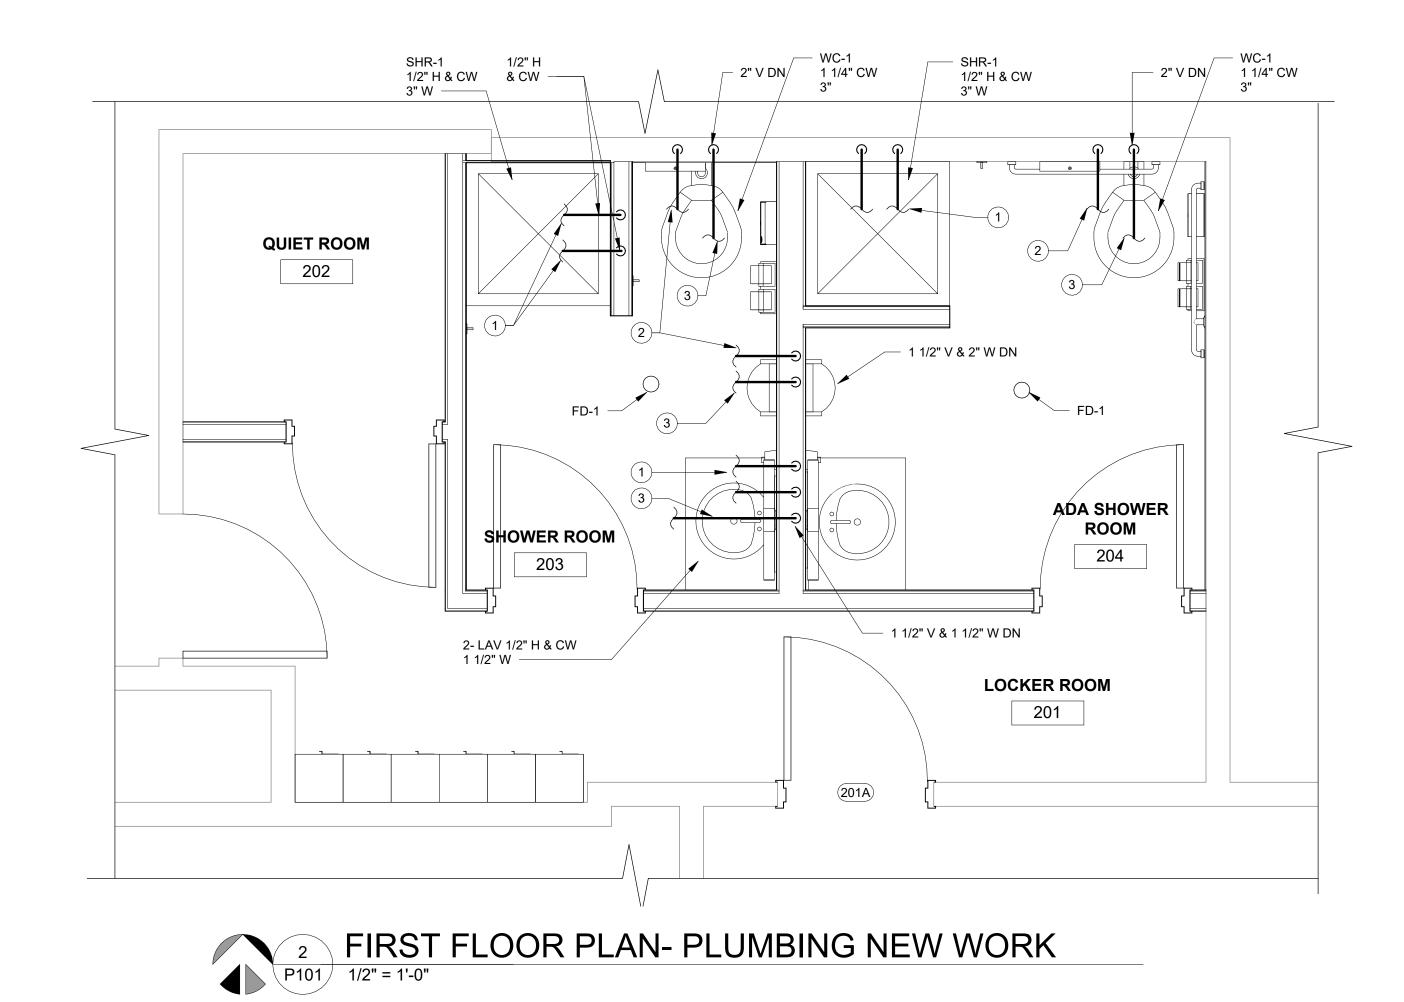
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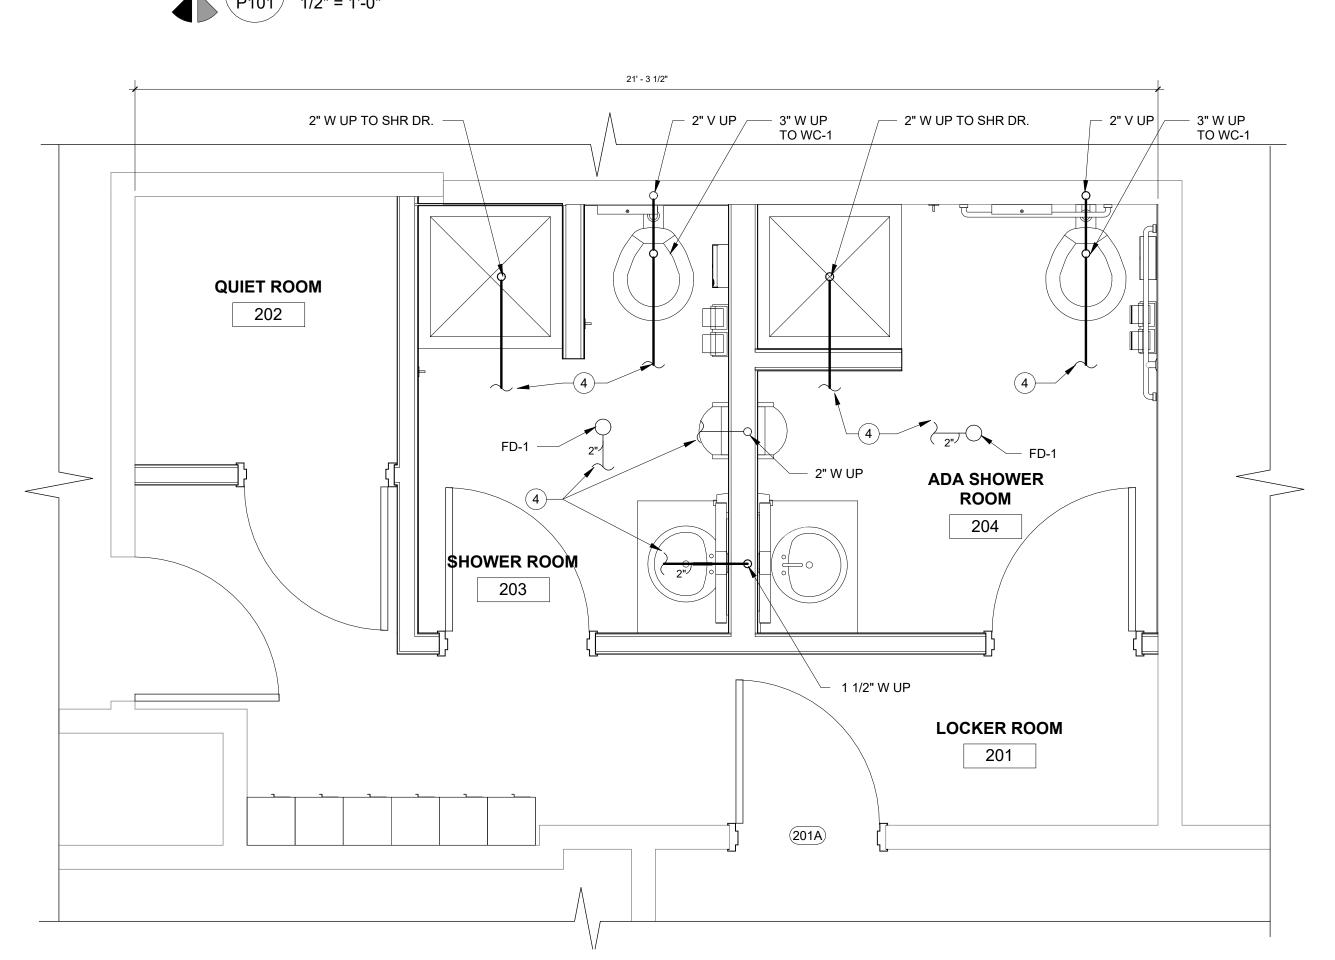
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PROJECT NO.

0242-0451

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MECHANICAL NEW WORK KEYNOTES:


- 1 H & CW CONNECT TO EXISTING
- CW CONNECT TO EXISTING
- VENT CONNECT TO EXISTING

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CLINTON TWP. FIRE STATION RENOVATIONS

STATION 2 & 3 **PLUMBING FLOOR PLANS**

CLINTON TOWNSHIP

DRAWN BY: CHECKED BY: DATE:

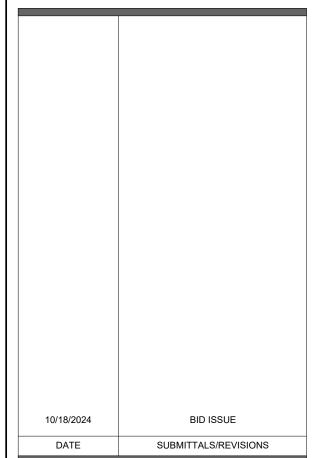MLB OCTOBER 2024 AS NOTED



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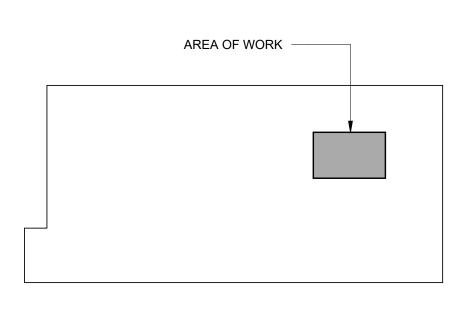
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PROJECT NO. 0242-0451

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1 FIRST FLOOR PLAN- UNDERGROUND PLUMBING
P101 1/2" = 1'-0"





DEMOLITION PLAN LEGEND :

EXTENT OF DEMOLITION WORK



NEW WORK CONNECT OT EXISTING




DEMOLITION WORK



---- NEW WORK

DEMOLITION PLAN KEYNOTES :

- REMOVE EXISTING PLUMBING FIXTURE PLUMBING. CAP PLUMBING IN FLOOR AND CEILING.
- REMOVE CEILING EXHAUST GRILLE (EG) AND CONNECTED DUCTWORK
- REMOVE EXISTING CEILING SUPPLY DIFFUSER (CD) AND CONNECTED DUCTWORK AS NOTED.
- REMOVE EXISTING ROOF EXHAUST FAN. ROOF FAN SHALL BE REPLACED. SEE NEW WORK.

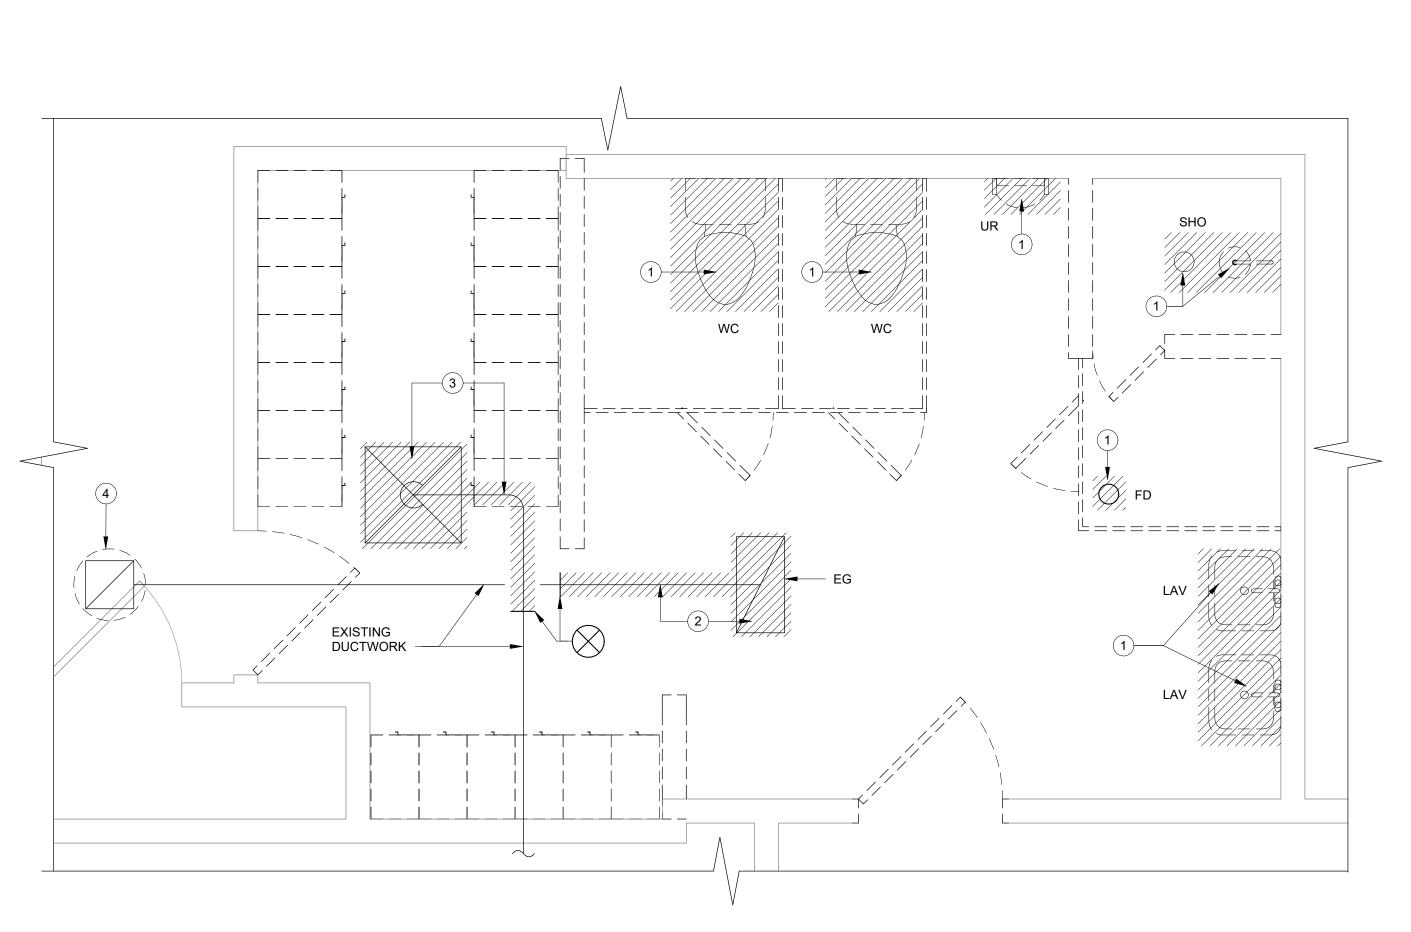






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CLINTON TWP. FIRE STATION RENOVATIONS

FIRE STATION 2 & 3 **MECHANICAL** FLOOR PLAN -DEMO @ TOILET / LOCKERS ROOM

CLINTON TOWNSHIP

DRAWN BY: CHECKED BY: DATE:
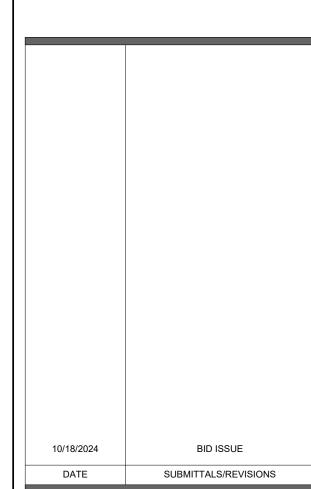
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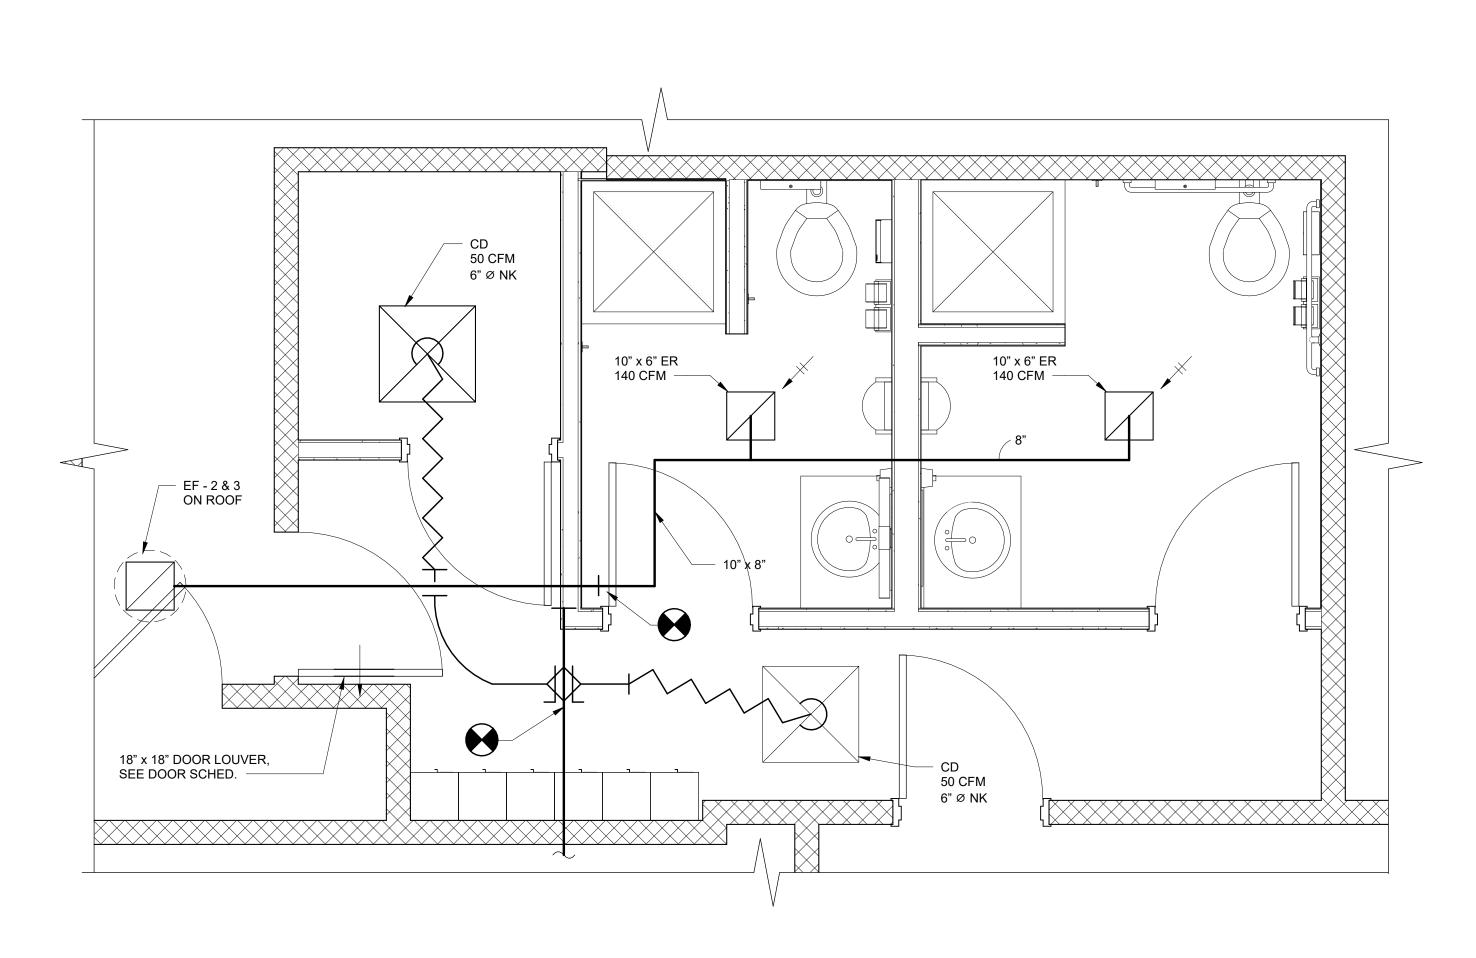
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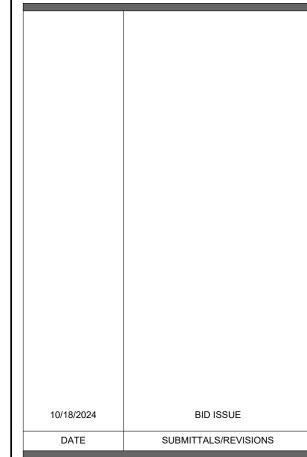
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PROJECT NAM

CLINTON TWP. FIRE STATION RENOVATIONS

SHEET

FIRE STATION No. 2 & 3 - HVAC FLOOR PLAN

CLINTON TOWNSHIP

PRELIMINAR	Y CONSTRU	CTION RECORI
DRAWN BY:	CHECKED BY:	DATE:
AGP	MLB	OCTOBER 2024
SCALE:		
	AS NOTED	
	DRAWN BY:	AGP MLB SCALE:



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M101

		LUMINAIRE S	CHEDULE		
FIXTURE SYMBOL	FIXTURE TAG	DESCRIPTION	MANUFACTURER(S)	LAMP SOURCE	WATTS
	A	2'x2' LOW PROFILE TROFFER EDGE LIT FLAT PANEL LED LUMINAIRE. A FULLY LUMINOUS APPEARANCE GLARE FREE. SUITABLE FOR RECESS MOUNTING IN DRYWALL CEILING, ALUMINUM FRAME WITH SATIN WHITE LENS, 3400 LUMENS, ELECTRONIC DRIVER, 4000K. 0-10V DIMMING CAPABLE, UNIVERSAL VOLTAGE.	1. LITHONIA EPANL LED FLAT PANEL 2. COOPER LIGHTING 3. COLUMBIA LIGHTING	LP840 80CRI 3400 LUMENS	30.8
0	В	6" DIAMETER HIGH BRIGHTNESS LIGHT EMITTING DIODES (LED'S) RECESS MOUNTED LED DOWNLIGHT SUITABLE FOR INSTALLATION IN DRYWALL OR LAY-IN TYPE CEILING CONSTRUCTION. WIDE DISTRIBUTION, MATT DIFFUSE ALUMINUM REFLECTOR WITH CLEAR APERTURE/TRIM, CONSTANT CURRENT LED DRIVER, 0-10V DIMMING DRIVER DOWN TO 10% MVOLT OPERATION. NOMINAL 3000 LUMEN OUTPUT.	1. LITHONIA LIGHTING CAT# LDN6 30 SW W1 L06 AR LD MVOLT GZ10 2. COOPER LIGHTING 3. COLUMBIA LIGHTING	LED 4000°K MVOLT 85CRI	32.9
0	BB	SAME AS TYPE B IN EVERYWAU EXCEPT WITH LOWER LUMEN PACKAGE AT 2000 LUMENS	1. LITHONIA LIGHTING CAT# LDN6 20 SW W1 L06 AR LD MVOLT GZ10 2. COOPER LIGHTING 3. COLUMBIA LIGHTING	LED 4000°K MVOLT 85CRI	25.9
0	BL	SAME AS TYPE BB IN EVERYWAU EXCEPT WITH SHOWER LENS,	1. LITHONIA LIGHTING CAT# LDN6 20 SW W1 L06 AR LD MVOLT GZ10 2. COOPER LIGHTING 3. COLUMBIA LIGHTING	LED 4000°K MVOLT 85CRI	25.9
	C	24" LONG ABOVE MIRROR VANITY FIXTURE. DECORATIVE LED. MOLT OPERATION. NOMINAL 2000 LUMEN OUTPUT, 4000K. COLOR TO BE SELECTED BY ARCHITECT.	1. LITHONIA LIGHTING CAT# LDN6 30 SW W1 L06 AR LD MVOLT GZ10	LED 4000°K MVOLT 85CRI	32.9
•	(#E)	SAME AS TYPE # EXCEPT WITH A BUILT-IN EMERGENCY BATTERY PACK. WIRE SUCH THAT IT OPERATES NORMALLY WITH OTHER FIXTURES AND OPERATES AS AN EMFIXTURE UPON LOSS OF NORMAL POWER.			

LUMINAIRE SCHEDULE GENERAL NOTES

- 1. REFER TO ELECTRICAL SPECIFICATIONS FOR MORE INFORMATION.
- 2. ALL LIGHT FIXTURES SHALL BE UL LABELED.
- 3. FIRST MANUFACTURER LISTED IS BASIS OF DESIGN. OTHER MANUFACTURERS LISTED ARE APPROVED MANUFACTURERS.
- 4. ELECTRICAL TRADES SHALL PROVIDE COMPLETE SUBMITTALS (SHOP DRAWINGS) ON ALL LIGHT FIXTURES, LAMPS, CONTROLS AND ACCESSORIES, ETC. REFER TO SPECIFICATION FOR SUBMITTAL FORMAT AND PROCESS.
- 5. ALL LUMINAIRES AND CONTROLS SHALL COMPLY WITH THE MICHIGAN UNIFORM ENERGY CODE AND ASHRAE 90.1.

LIGHTING SYMBOL LIST

SYMBOL	DESCRIPTION
	LIGHT FIXTURE - CEILING/GRID MOUNT
<u> </u>	LIGHT FIXTURE - INTERIOR WALL MOUNT LINEAR
ô	LIGHT FIXTURE - DOWNLIGHT WITH WALLWASH DIST.
	LIGHT FIXTURE - INTERIOR WALL SCONCE
-	LIGHT FIXTURE - INTERIOR SURFACE MOUNT
О	LIGHT FIXTURE - INTERIOR WALL MOUNTED
	LIGHT FIXTURE - INTERIOR PENDANT MOUNT
	LIGHT FIXTURE - INTERIOR PENDANT MOUNT CYLINDER
	TRACK AND TRACK MOUNTED LIGHT FIXTURES
⊗	EXIT LIGHT — CEILING MOUNTED — ARROWS AS INDICATED ON PLAN (SHADED AREA INDICATES FACE(S) OF FIXTURE)
₽	EXIT LIGHT — WALL MOUNTED — ARROWS AS INDICATED ON PLAN (SHADED AREA INDICATES FACE(S) OF FIXTURE)
	EMERGENCY LIGHT FIXTURE - EMERGENCY BATTERY UNIT
484	EMERGENCY LIGHT FIXTURE - BATTERY UNIT/EXIT SIGN
- □	LIGHT FIXTURE - EXTERIOR POLE MOUNT TYPE
早	LIGHT FIXTURE - EXTERIOR WALL MOUNT TYPE
	LIGHT FIXTURE - EXTERIOR POST TOP TYPE
•	LIGHT FIXTURE - EXTERIOR BOLLARD TYPE
	MBOLS AS INDICATED ON PLANS ARE NOT SCALE UNLESS NOTED OTHERWISE.

LIGHTING CONTROLS LEGEND

SYMBOL	DESCRIPTION
\$	SWITCH SINGLE POLE
\$ _o	OCCUPANCY SENSOR SWITCH
\$ _V	VACANCY SENSOR SWITCH
\$ _D	LOW VOLTAGE DIMMER SWITCH
\$ _{VD}	VACANCY DIMMER SENSOR SWITCH
(03)	CEILING MOUNTED OCCUPANCY SENSOR
(VS)	CEILING MOUNTED VACANCY SENSOR
\$ ₃	SWITCH THREE-WAY

SINGLE POLE KEY SWITCH

POWER SYMBOL LIST

SYMBOL	DESCRIPTION
•	CONDUIT DOWN
0	CONDUIT UP
С	CONTACTOR
4	DISCONNECT SWITCH - NON FUSED
4	DISCONNECT SWITCH - FUSED
	DISCONNECT SWITCH - COMB. MOTOR STARTER
	ELECTRICAL PANEL - 208/240 VOLTS
	ELECTRICAL PANEL - 480 VOLTS
lacktriangle	GROUNDING ROD
=	GROUND
	GROUNDING BAR
	JUNCTION BOX
	JUNCTION BOX WITH HARDWIRED CONNECTION
M	METER
\searrow	MOTOR - SINGLE PHASE
\	MOTOR - THREE PHASE
\$м	MOTOR RATED SWITCH
φ	POWER RECEPTACLE - SIMPLEX TYPE
Ψ	POWER RECEPTACLE - DUPLEX TYPE
 	POWER RECEPTACLE - DUPLEX 6" ABOVE COUNTER
⊕ usb	POWER RECEPTACLE - USB/DUPLEX COMBO. DEVICE
 	POWER RECEPTACLE - QUADRUPLEX TYPE
\Box	POWER RECEPTACLE - RECESSED FLOOR TYPE
Θ	POWER RECEPTACLE - SPECIALTY TYPE
SPD	SURGE PROTECTION DEVICE
ТС	TIME CLOCK
Т	TRANSFORMER (REFER TO SCHEDULES FOR INFO)
	VARIABLE SPEED DRIVE

1. ALL DEVICE RATINGS/SIZES SHALL BE COORDINATED WITH PLANS AND SCHEDULES.

AUXILIARY SYST. SYMBOL LIST

SYMBOL	DESCRIPTION
	CAMERA
CR	CARD READER
$\overline{}$	COMMUNICATIONS DEVICE - 6" ABOVE COUNTER
$\overline{\nabla}$	COMMUNICATIONS DEVICE - FLOOR
∇	COMMUNICATIONS DEVICE - WALL
DH	MAGNETIC DOOR HOLDER
•	PUSH BUTTON
S	SPEAKER
$\vdash \bigcirc$	WALL CLOCK - SINGLE FACE
$\vdash \bigoplus$	WALL CLOCK - DOUBLE FACE
	WALL CLOCK AND SPEAKER UNIT
	CONTRACTOR SHALL BE RESPONSIBLE FOR CONDUIT FOR ALL DEVICES INDICATED.

2. LOW VOLTAGE CONTRACTOR SHALL PROVIDE EXACT

SPECIFICATIONS AND LOCATIONS OF ALL DEVICES.

ELECTRICAL ABBREVIATIONS

HAND-OFF-AUTO

ISOLATED GROUND

KILOVOLT AMPERE

KILOWATT HOUR

LIGHTING PANEL

MAIN LUG ONLY

MAXIMUM

MINIMUM

NON-FUSIBLE

NORMALLY CLOSED

NORMALLY OPEN

NOT IN CONTRACT

POLE

POWER FACTOR

MAIN CIRCUIT BREAKER

MAIN DISTRIBUTION PANEL

NATIONAL ELECTRICAL CODE

NATIONAL ELECTRICAL MANUFACTURERS ASSOCIATION

OWNER FURNISHED / CONTRACTOR INSTALLED

OWNER FURNISHED / OWNER INSTALLED

RELOCATED EXISTING ELECTRICAL EQUIPMENT

POLYVINYL CHOLRIDE (PLASTIC)

REMOVE AND REINSTALL

RIGID METALLIC CONDUIT

TELEPHONE BACKBOARD

UNDERWRITERS LABORATORIES

UNIVERSAL SERIAL BUS

UNINTERRUPTIBLE POWER SUPPLY

RECEPTACLE PANEL

SPECIFICATIONS

UNDER COUNTER

TYPICAL

VOLT

WATT

VOLT AMPERE

WIRE GUARD

WEATHERPROOF

TRANSFORMER

HORSEPOWER

KILOVOLT

KILOWATT

MLO

N/NEU


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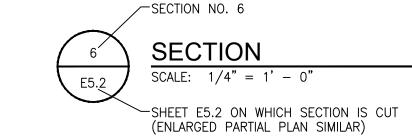
USB

			DRAWING INDEX
ABBREV.	DESCRIPTION		
AFF	ABOVE FINISHED FLOOR	SHEET #	DESCRIPTION
Α	AMPERE	E100	ELECTRICAL GENERAL INFORMATION
AF	AMPERE FUSE/AMPERE FRAME	E101	FIRE STATION 4 ELECTRICAL PLANS
AWG	AMERICAN WIRE GAUGE	F103	FIRE CTATIONS 20.2 FLECTRICAL DIANS
AT	AMPERE TRIP	E102	FIRE STATIONS 2&3 ELECTRICAL PLANS
ATS	AUTOMATIC TRANSFER SWITCH	ED101	FIRE STATION 4 ELECTRICAL DEMOLITION PLAN
AIC	AVAILABLE INTERRUPTING CURRENT (AMPS)	ED102	FIRE STATION 2&3 ELECTRICAL DEMOLITION PLAN
С	CONDUIT OR CEILING MOUNTED	E300	SPECIFICATIONS AND DETAILS
СВ	CIRCUIT BREAKER	E300	SPECIFICATIONS AND DETAILS
CU	COPPER		
CT	CURRENT TRANSFORMER		
DIA	DIAMETER		
DISC	DISCONNECT		
EMT	ELECTRICAL METALLIC TUBING		
EWC	ELECTRIC WATER COOLER		
EP0	EMERGENCY POWER OFF		
(E)	EXISTING ELECTRICAL EQUIPMENT OR WORK		
FA	FIRE ALARM		
FACP	FIRE ALARM CONTROL PANEL		
FLA	FULL LOAD AMPS		
F	FUSE	_	
G/GRD	GROUND		DRAWING NOTATION
GFCI/GFI	GROUND FAULT CIRCUIT INTERRUPTER	SYMBOL	DESCRIPTION

	DRAWING NOTATION
SYMBOL	DESCRIPTION
A	LIGHTING FIXTURE TAG
$\langle 1 \rangle$	CONSTRUCTION KEY NOTE NUMBER 1
1	DEMOLITION KEY NOTE NUMBER 1
1	FEEDER SIZE TAG (REFER TO FEEDER SCHEDULE ON THIS SHEET)
EF 1	EQUIPMENT DESIGNATION, (I.E. EXHAUST FAN NUMBER 1)
	EXISTING DEVICES OR EQUIPMENT
	NEW OR MODIFIED DEVICES OR EQUIPMENT



---- NEW OR MODIFIED UNDERGROUND WIRING

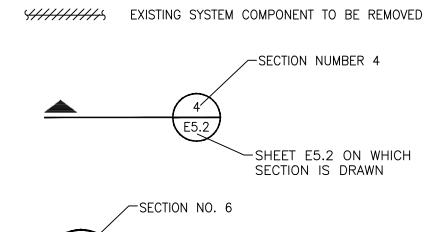

	APPLICABLE CODES AND REGULATIONS
YEAR	CODE
2015	MICHIGAN BUILDING CODE
2015	MICHIGAN ENERGY CODE
2014	MICHIGAN ELECTRICAL CODE RULES, PART 8
2017	NATIONAL ELECTRICAL CODE (NFPA 70)
2013	NFPA 20
2013	NFPA 72
2012	NFPA 101
2013	NFPA 110
2009	ICC A117.1 ACCESSIBLE AND USABLE BUILDINGS & FACILITIES




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PROJECT NAME:

CLINTON TWP. FIRE STATION RENOVATIONS

SHEET TITLE: **ELECTRICAL NOTES**

CLINTON TOWNSHIP

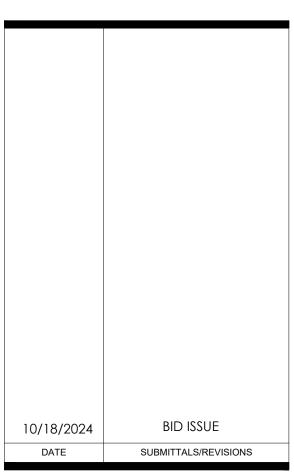PRELIMINAR	Y CONSTRU	CTION RECORD
DRAWN BY:	CHECKED BY:	DATE:
LD ML	В	AUGUST 2023
SCALE:	•	
	AS NOTED	

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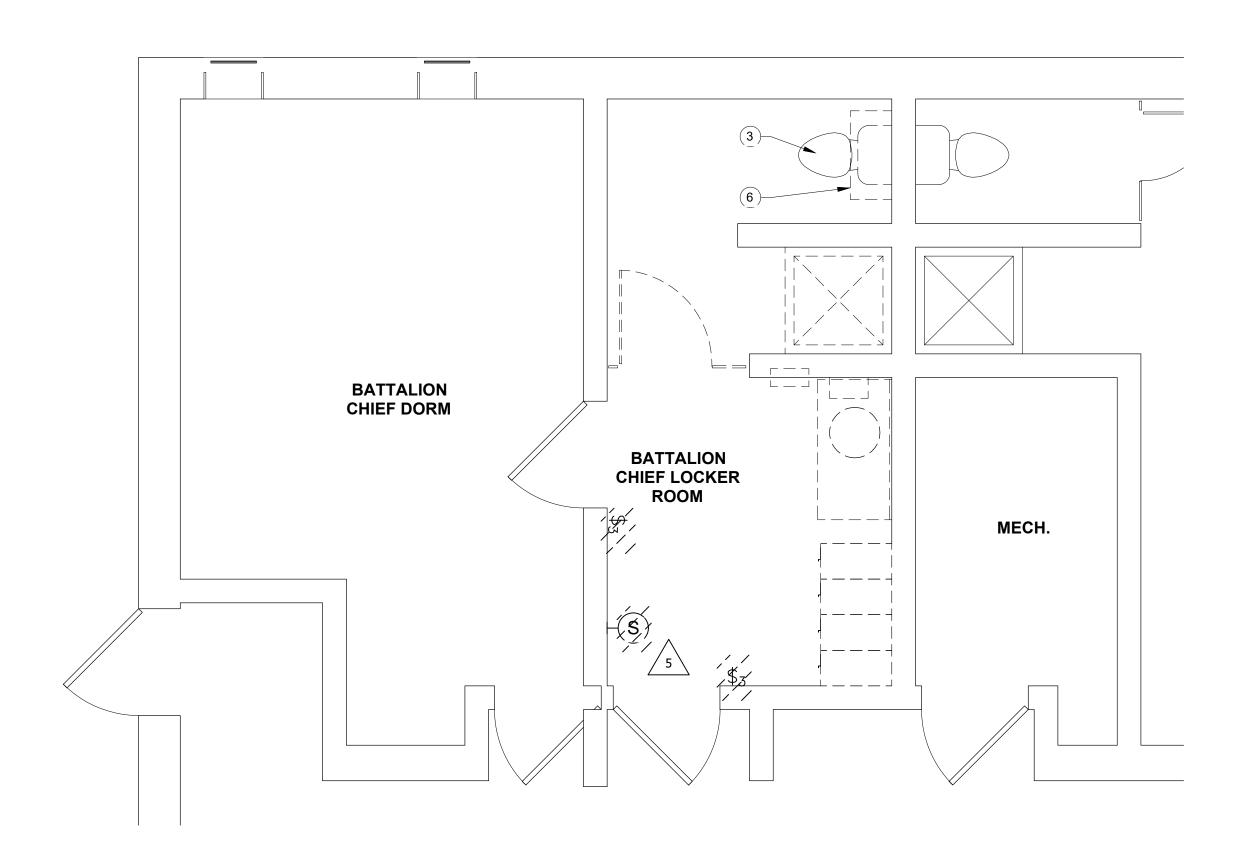
DURING CONSTRUCTION, THE CONTRACTOR SHALL USE EXTREME CAUTION WHEN OPERATING NEAR ANY AND ALL

PROJECT NO.


OVERHEAD AND / OR BURIED UTILITIES.


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	GENERAL DEMOLITION NOTES
А	THESE DRAWINGS ARE DIAGRAMMATIC AND INDICATE THE GENERAL EXTENT OF WORK TO BE PERFORMED. THE EXACT EXTENT OF DEMOLITION SHALL BE DETERMINED BY THE NEW WORK.
В	ANY INTERRUPTIONS OF EXISTING SERVICES AND/OR EQUIPMENT SHALL BE PERFORMED AT A TIME APPROVED IN ADVANCE BY THE OWNER'S REPRESENTATIVE SO AS NOT TO INTERFERE WITH THE PRESENT BUILDING'S OPERATION.
С	PRIOR TO COMMENCEMENT OF WORK, CONTRACTOR SHALL VISIT THE SITE AND BECOME FAMILIAR WITH EXISTING SITE CONDITIONS, SYSTEMS, AND UTLITIES. NOTIFY DESIGN PROFESSIONAL OF ANY INTERFERENCES OR DISCREPENCIES.
D	ALL ITEMS INDICATED WITH CROSS-HATCHING SHALL BE REMOVED COMPLETE WITH ALL RELATED ITEMS INCLUDING HANGARS, SUPPORTS, INSULATION, CONTROLS, ETC. CAP ALL OPEN ENDED PIPES AND DUCTS.
E	THE OWNER SHALL HAVE FIRST RIGHT OF REFUSAL ON ALL EQUIPMENT BEING REMOVED. ALL ITEMS REMOVED SHALL BE LEGALLY DISPOSED OF. GENERAL CONTRACTOR SHALL BE RESPONSIBLE FOR ALL EXISTING RELOCATED AND OWNER PROVIDED EQUIPMENT.
F	VERIFY DEPTH, SIZE, LOCATIONS, AND CONDITIONS OF EXISTING UTILITIES IN THE FIELD. INCLUDING POINTS OF CONNECTION PRIOR TO STARTING ANY WORK.
G	ALL ITEMS ON DEMOLITION PLAN SHALL BE CONSIDERED EXISTING UNLESS OTHERWISE NOTED. ALL WORK INDICATED ON PLANS HAS BEEN LOCATED PER EXISTING DRAWINGS AND/OR FIELD OBSERVATION AND REQUIRES FIELD VERIFICATION.
Н	ALL EXISTING WORK TO REMAIN SHALL BE PROTECTED FROM DAMAGE. WHERE DUCT WORK PIPE INSULATION HAS BEEN DAMAGED DURING DEMOLITION, THE CONTRACTOR SHALL REPAIR INSULATION AS REQUIRED TO MATCH EXISTING.

X	DEMOLITION KEYED NOTES
1	EXISTING 2"X4' LED STRIP SURFACE MOUNTED LIGHT FIXTURES AND SWITCHING TO BE REMOVED. REMOVE CONDUIT AND WIRING BACK TO JUNCTION BOX, EXISTING CIRCUIT TO REMAIN AND BE RE-USED FOR NEW LIGHTING.
2	EXISTING 6" ROUND RECESSED LIGHT FIXTURES AND SWITCHING TO BE REMOVED. REMOVE CONDUIT AND WIRING BACK TO JUNCTION BOX, EXISTING CIRCUIT TO REMAIN AND BE RE-USED FOR NEW LIGHTING.
3	EXISTING WALL MOUNTED VANITY FIXTURE TO BE REMOVED COMPLETE, REMOVE CONDUIT AND WIRING BACK TO SOURCE.
4	EXISTING RECESSED SPEAKER TO BE REMOVED, PROTECT WIRE FOR NEW SPEAKERS TO BE INSTALLED IN NEW CEILING.
5	EXISTING WALL MOUNTED RECESSED SPEAKER TO BE REMOVED. PROTECT WIRE TO BE RECONNECTED TO NEW SPEAKER, TO BE RE-INSTALLED IN NEW CEILING.
6	EXISTING EXHAUST FAN BEING REMOVED BY MECHANICAL TRADES, EC TO DISCONNECT AND PROTECT CIRCUIT TO BE USED FOR NEW FAN, REFER TO NEW WORK PLANS.




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Michigan 48315
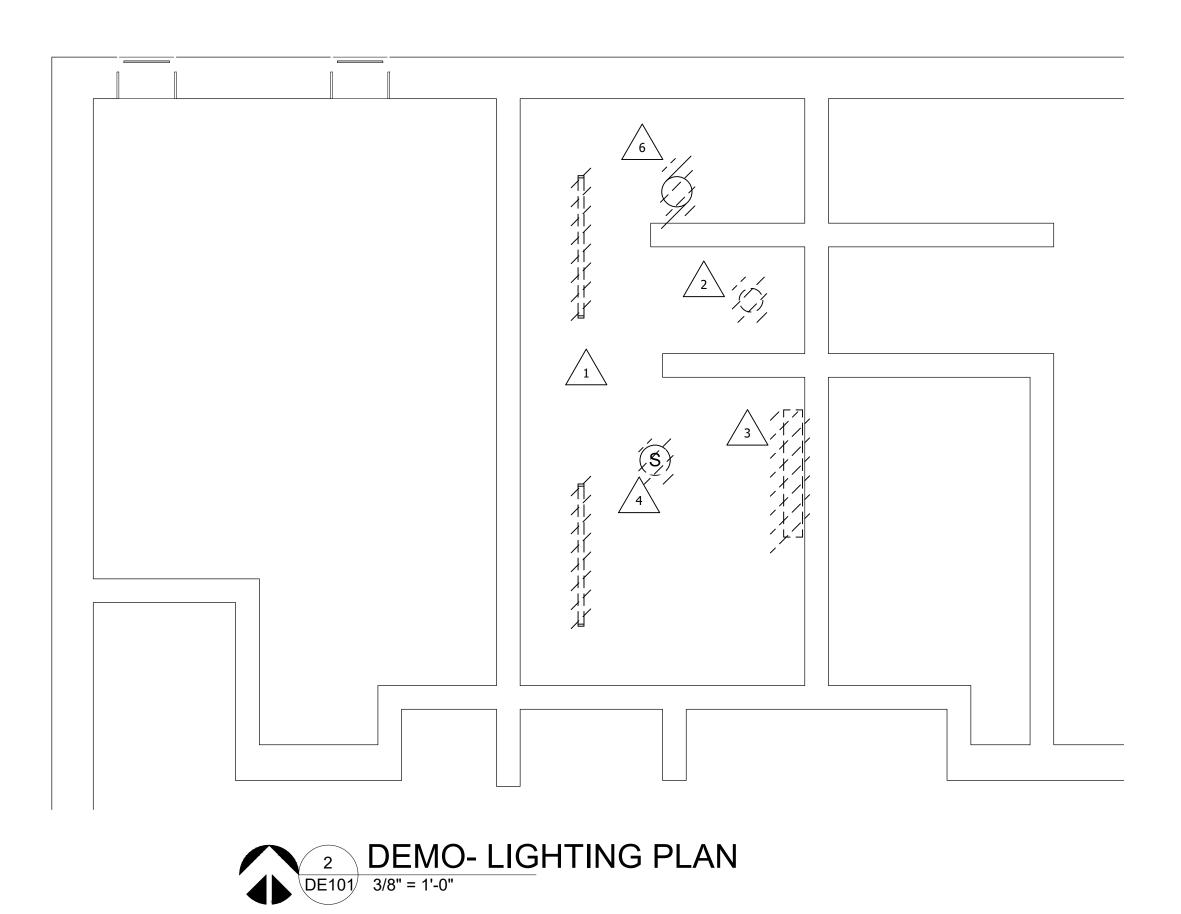
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PROJECT NAME:

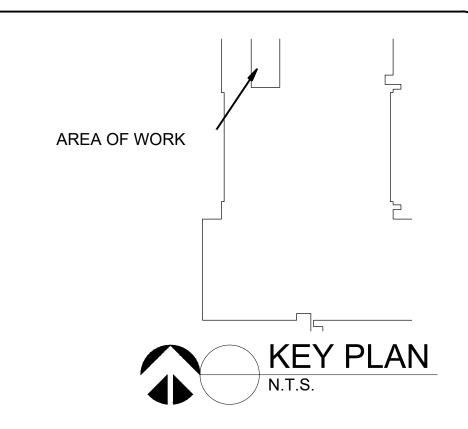CLINTON TWP. FIRE STATION RENOVATIONS

SHEET TITLE:

COMMAND LOCKER ELECTRICAL DEMO PLANS

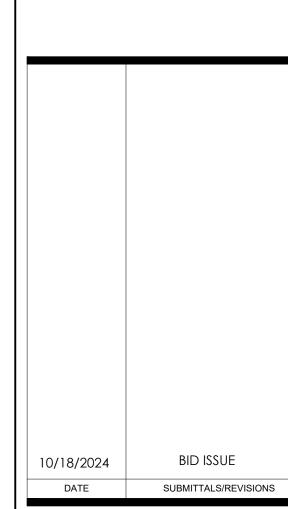CLINTON TWP.

PRELIMINARY CONSTRUCTION RECORD		
DRAWN BY:	CHECKED BY:	DATE:
FA	JRA	DECEMBER 2023
SCALE: AS NOTED		

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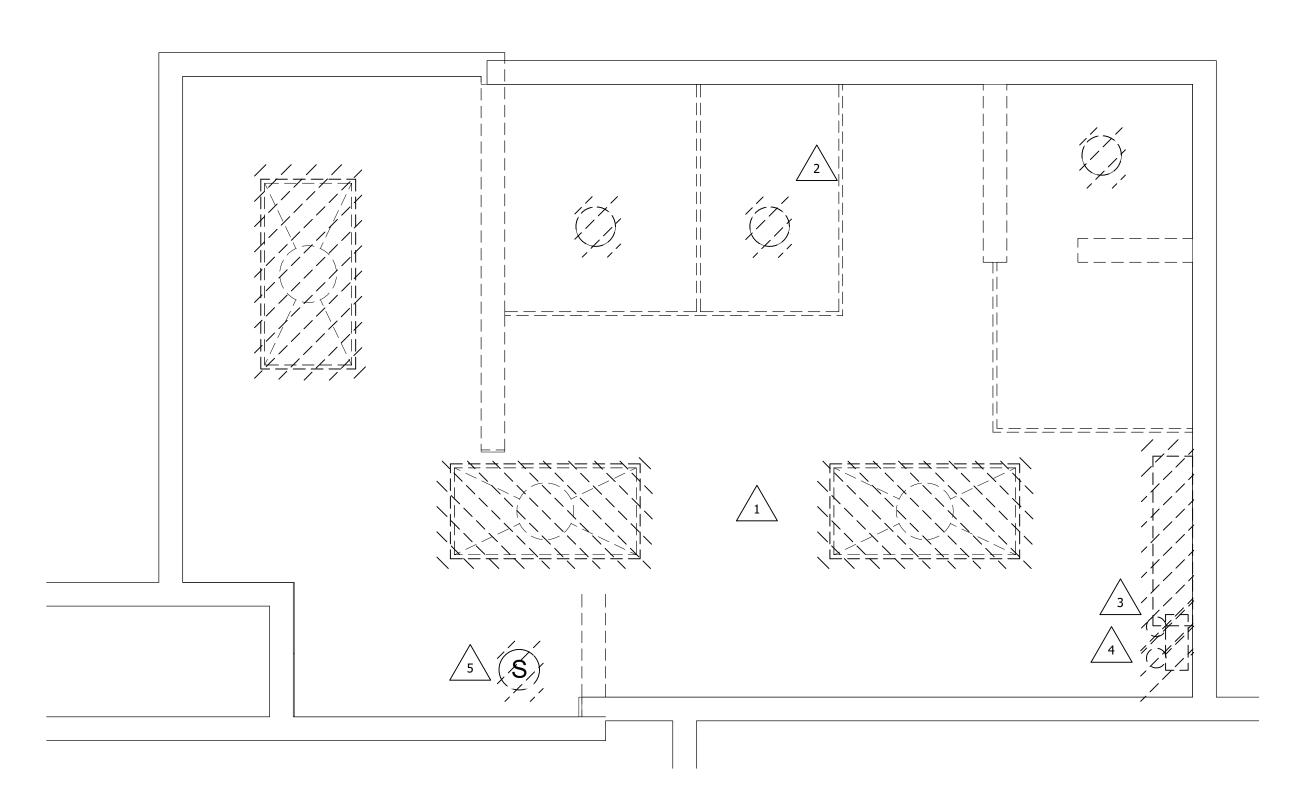
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PROJECT NO.


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GENERAL DEMOLITION NOTES

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- ALL EXISTING WORK TO REMAIN SHALL BE PROTECTED FROM DAMAGE. WHERE DUCT WORK PIPE INSULATION HAS BEEN DAMAGED DURING DEMOLITION, THE CONTRACTOR SHALL REPAIR INSULATION AS REQUIRED TO MATCH EXISTING.

DEMOLITION KEYED NOTES

- EXISTING 2X4 LED FLAT PANEL RECESSED LIGHT FIXTURES AND SWITCHING TO BE REMOVED. REMOVE CONDUIT AND WIRING BACK TO JUNCTION BOX, EXISTING CIRCUIT TO REMAIN AND BE RE-USED FOR NEW LIGHTING.
- EXISTING 6" ROUND RECESSED LIGHT FIXTURES AND SWITCHING TO BE REMOVED. REMOVE CONDUIT AND WIRING BACK TO JUNCTION BOX, EXISTING CIRCUIT TO REMAIN AND BE RE-USED FOR NEW LIGHTING.
- 3 EXISTING WALL MOUNTED VANITY FIXTURE TO BE REMOVED COMPLETE, REMOVE CONDUIT AND WIRING BACK TO SOURCE.
- 4 EXISTING EMERGENCY FIXTURE TO BE REMOVED COMPLETE, REMOVE CONDUIT AND WIRING BACK TO SOURCE.
- EXISTING SPEAKER LOCATED ABOVE CEILING TO BE REMOVED, WIRE TO BE PROTECTED, TO FEED NEW SPEAKER IN NEW CEILING.
- EXISTING WALL MOUNTED RECESSED SPEAKER TO BE REMOVED. PROTECT WIRE

 TO BE RECONNECTED TO NEW SPEAKER, REFER TO NEW S[EAKER IN NEW
- CEILING.

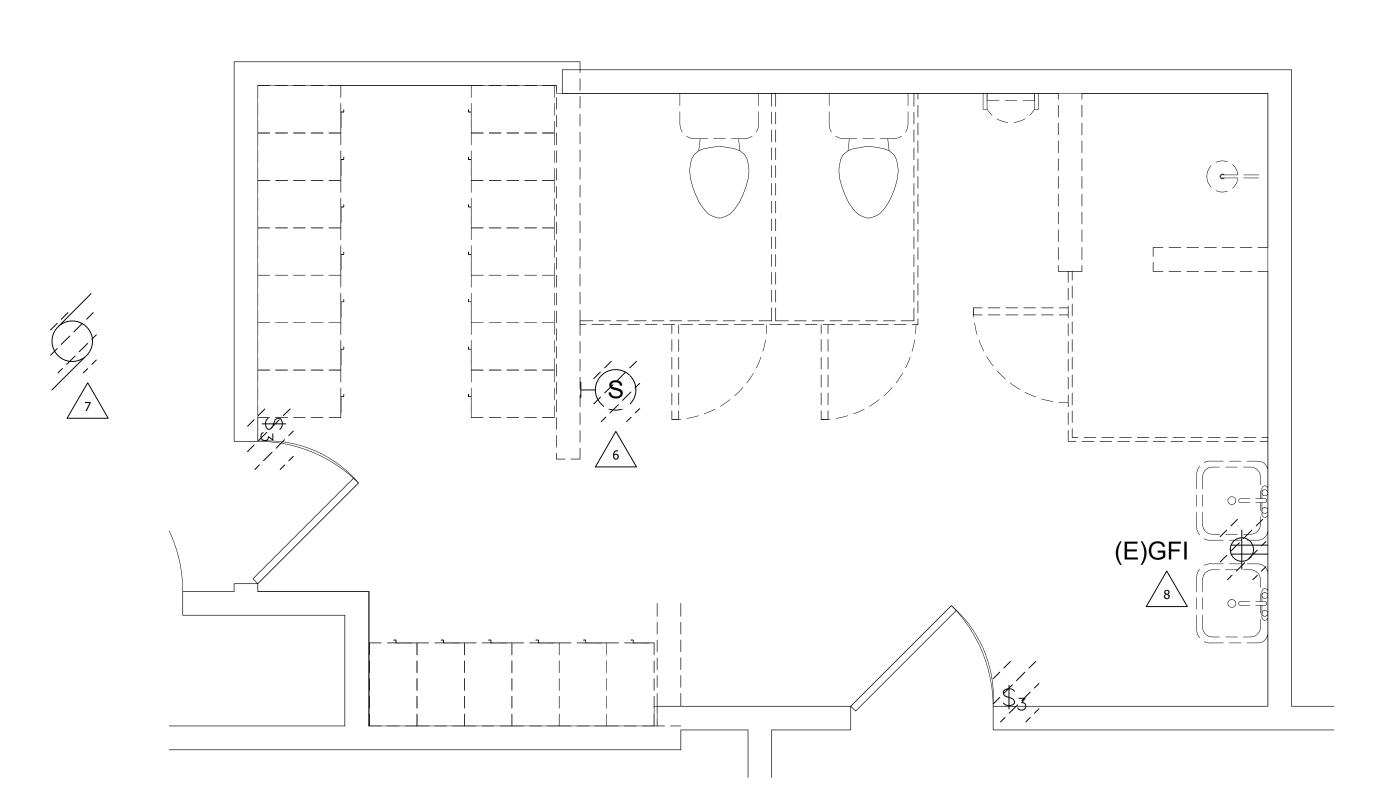 EXISTING EXHAUST FAN BEING REMOVED BY MECHANICAL TRADES, EC TO
- 7 DISCONNECT AND PROTECT CIRCUIT TO BE USED FOR NEW FAN, REFER TO NEW WORK PLANS.
- 8 EXISTING GFI RECEPTACLE TO BE REMOVED, EXISTING CIRCUIT TO BE REUSED FOR NEW RECEPTACLES, REFER TO NEW PLANS.




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CLINTON TWP. FIRE STATION RENOVATIONS

SHEET TITLE:

GENERAL ELECTRICAL DEMO PLANS

CLINTON TOWNSHIP

PRELIMINARY CONSTRUCTION RECORD		
DRAWN BY:	CHECKED BY:	DATE:
ARD JR	A	DECEMBER 2023
SCALE:		
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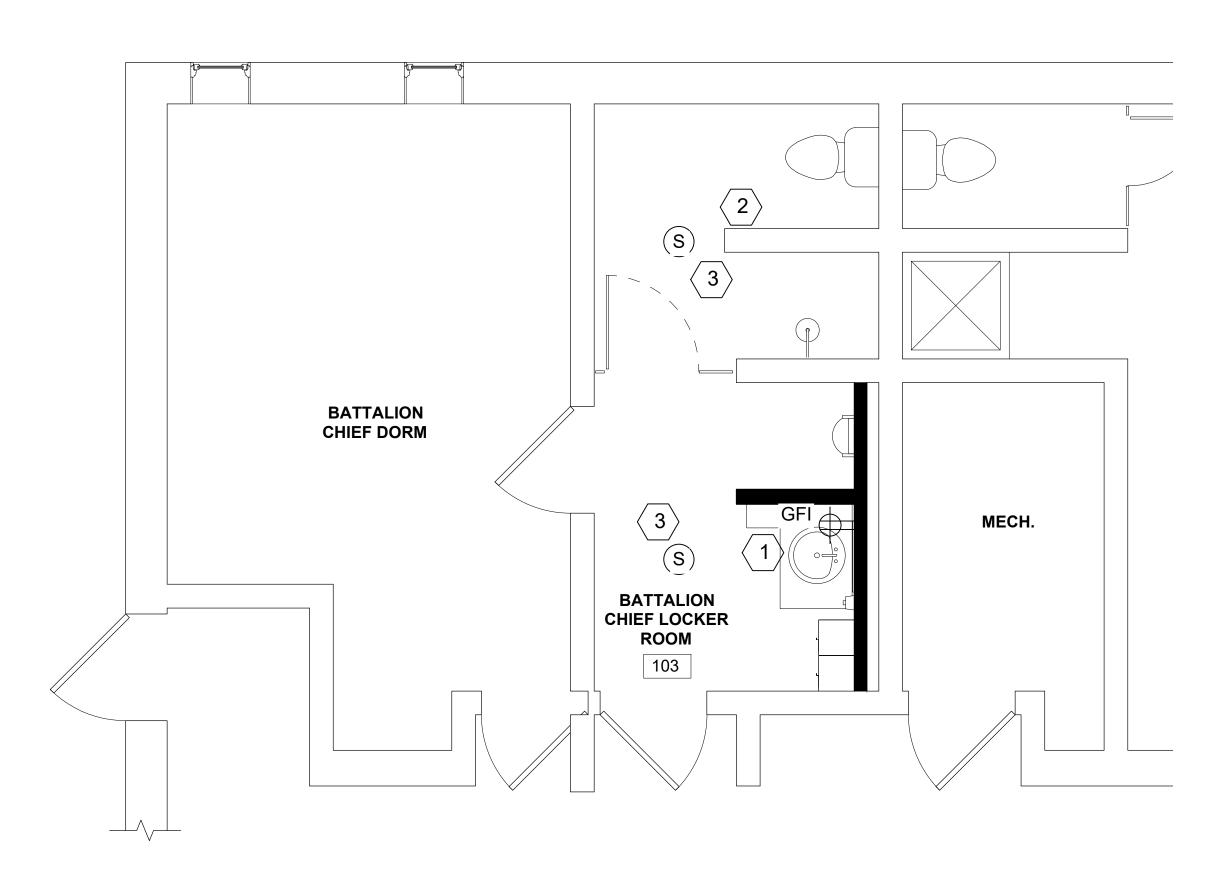
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PROJECT NO.

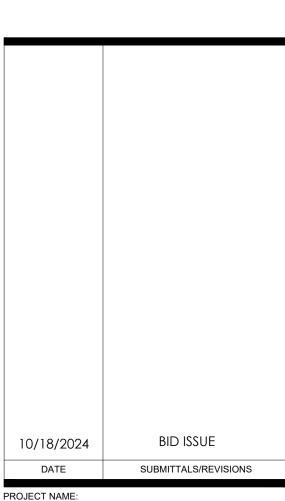
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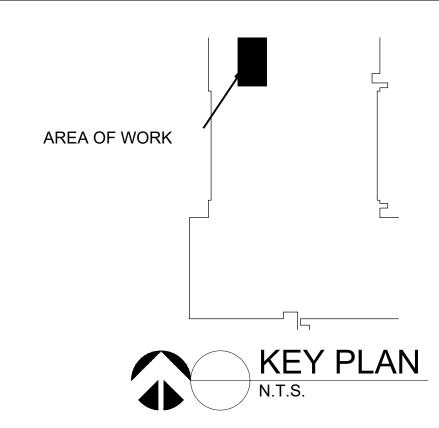
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ELECTRICAL GENERAL NOTES	
А	REFER TO ARCHITECTURAL REFLECTED CEILING PLAN FOR EXACT LOCATION OF ALL LIGHTING FIXTURES UNLESS OTHERWISE NOTED.
В	ANY 120 VOLT BRANCH CIRCUIT FEEDER LONGER THAN 120'-0" TO LAST DEVICE SHALL BE SIZED TO THE NEXT LARGER STANDARD AWG SIZE. E.C. SHALL FIELD VERIFY ALL LENGTHS OF FEEDERS
С	SEE LIGHT FIXTURE SCHEDULE SHEET E100. ALL ELECTRICAL DEVICES ON THIS SHEET SHALL BE NEW UNLESS OTHERWISE NOTED.
D	WHERE MORE THEN ONE LIGHT SWITCH IS INDICATED TO BE INSTALLED AT THE SAME LOCATION, THEY SHALL BE GROUPED UNDER ONE COMMON FACEPLATE.
E	ELECTRICAL CONTRACTOR SHALL COMPLY WITH THE LATEST NATIONAL ELECTRICAL CODE, LIFE SAFETY CODE AND APPLICABLE STATE AND LOCAL CODES AND ORDINANCES.

(#)	NEW POWER WORK KEYED NOTES
1	NEW GFIC RECEPTACLE TO BE MOUNTED AS SHOWN, AND ARE CONNECTED TO EXISTING RECEPTACLE CIRCUIT BEING AVAILABLE FROM DEMO WORK, UPDATE

CONDUITS IN FINISHED AREAS SHALL BE CONCEALED

ELECTRICAL EQUIPMENT AND WIRING SHALL BE NEW AND SHALL BE FURNISHED AND INSTALLED BY ELECTRICAL CONTRACTOR, UNLESS OTHERWISE NOTED.

WIRING SHALL BE IN CONDUIT. CONDUIT SHALL BE 3/4" CONDUIT MINIMUM.

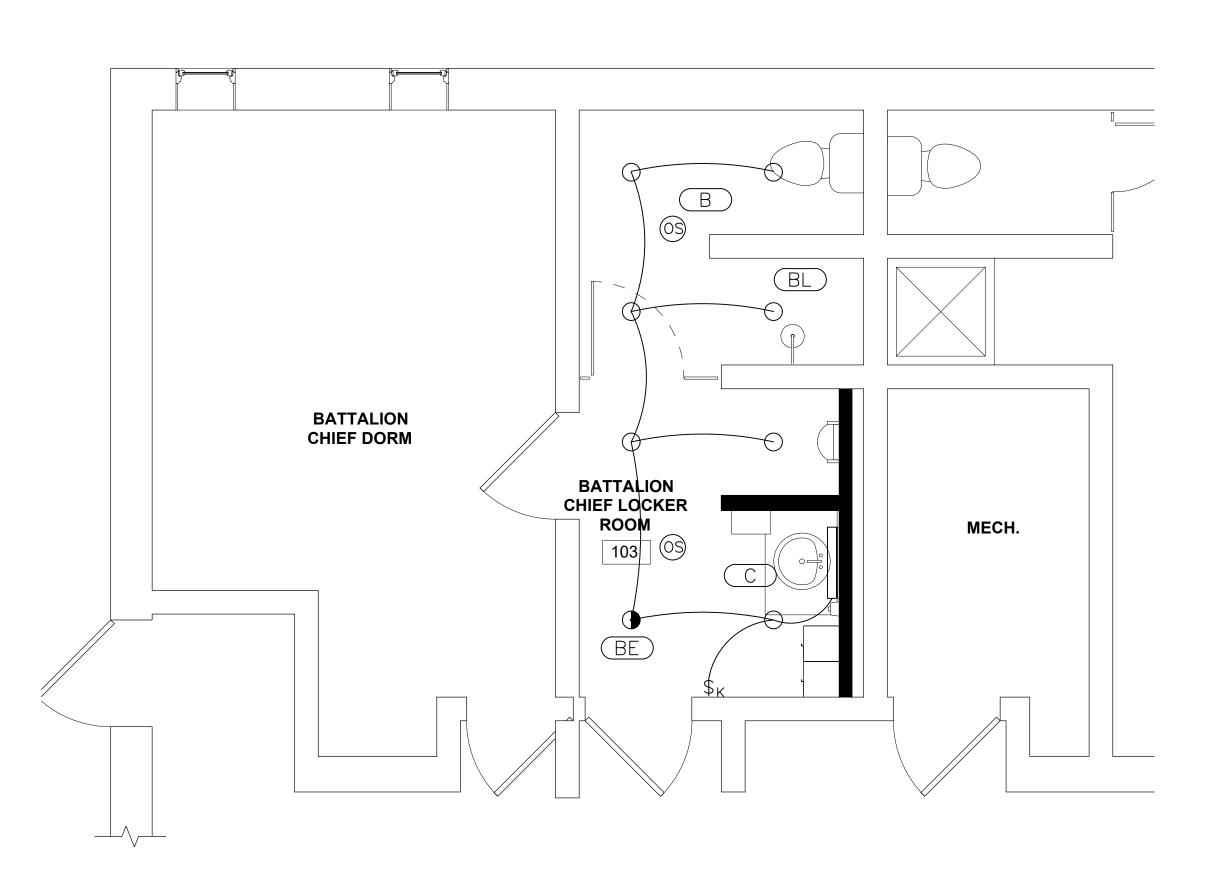PANEL SCHEDULE.

CONNECT NEW EXHAUST FAN EF-4 1/6HP 120V TO EXISTNIG CIRCUIT AVAILABLE FROM DEMO OF EXISTING FAN. FAN SHALL BE CONTROLLED FROM OCCUPANCY SENSOR LIGHT SWITCH.

NEW CEILING MOUNTED 8" ROUND SPEAKER. (ONE FROM EACH BUILDING SOUND SYSTEMS) CONNECT TO EXISTING SPEAKER CIRCUIT. EXTEND CONDUIT AND WIRING AS REQUIRED TO NEW LOCATION. VERIFY EXACT LOCATION IN THE FIELD WITH OWNER. NEW SPEAKER SHALL BE BY "JBL SPAKER" OR EQUAL.

(#)NEW LIGHTING WORK KEYED NOTES

NEW FIXTURES TYPE "A" TO BE CONNECTED/CIRCUITED TO EXISTING CIRCUIT AVAILABLE FROM DEMOLITION. CONTROL THRU CEILING MOUNTED OCCUPACY SENSOR. COORDINATE PLACEMENT OF SENSORS WITH LIGHTING CONTROLS SUPPLIER.

NEW LIGHT FIXTURES TO BE CONNECT TO EXISTING CIRCUIT BEING AVAILABLE FROM DEMOLITION WORK. ALL CONDUIT, WIRING AND CONTROLS SHALL BE NEW AS SHOWN.


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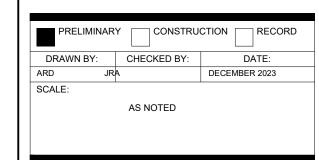


CLINTON TWP. FIRE STATION RENOVATIONS

SHEET TITLE:

COMMAND ELECTRIAL PLANS

CLINTON TWP.

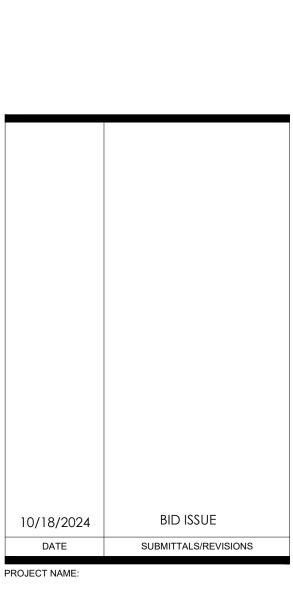

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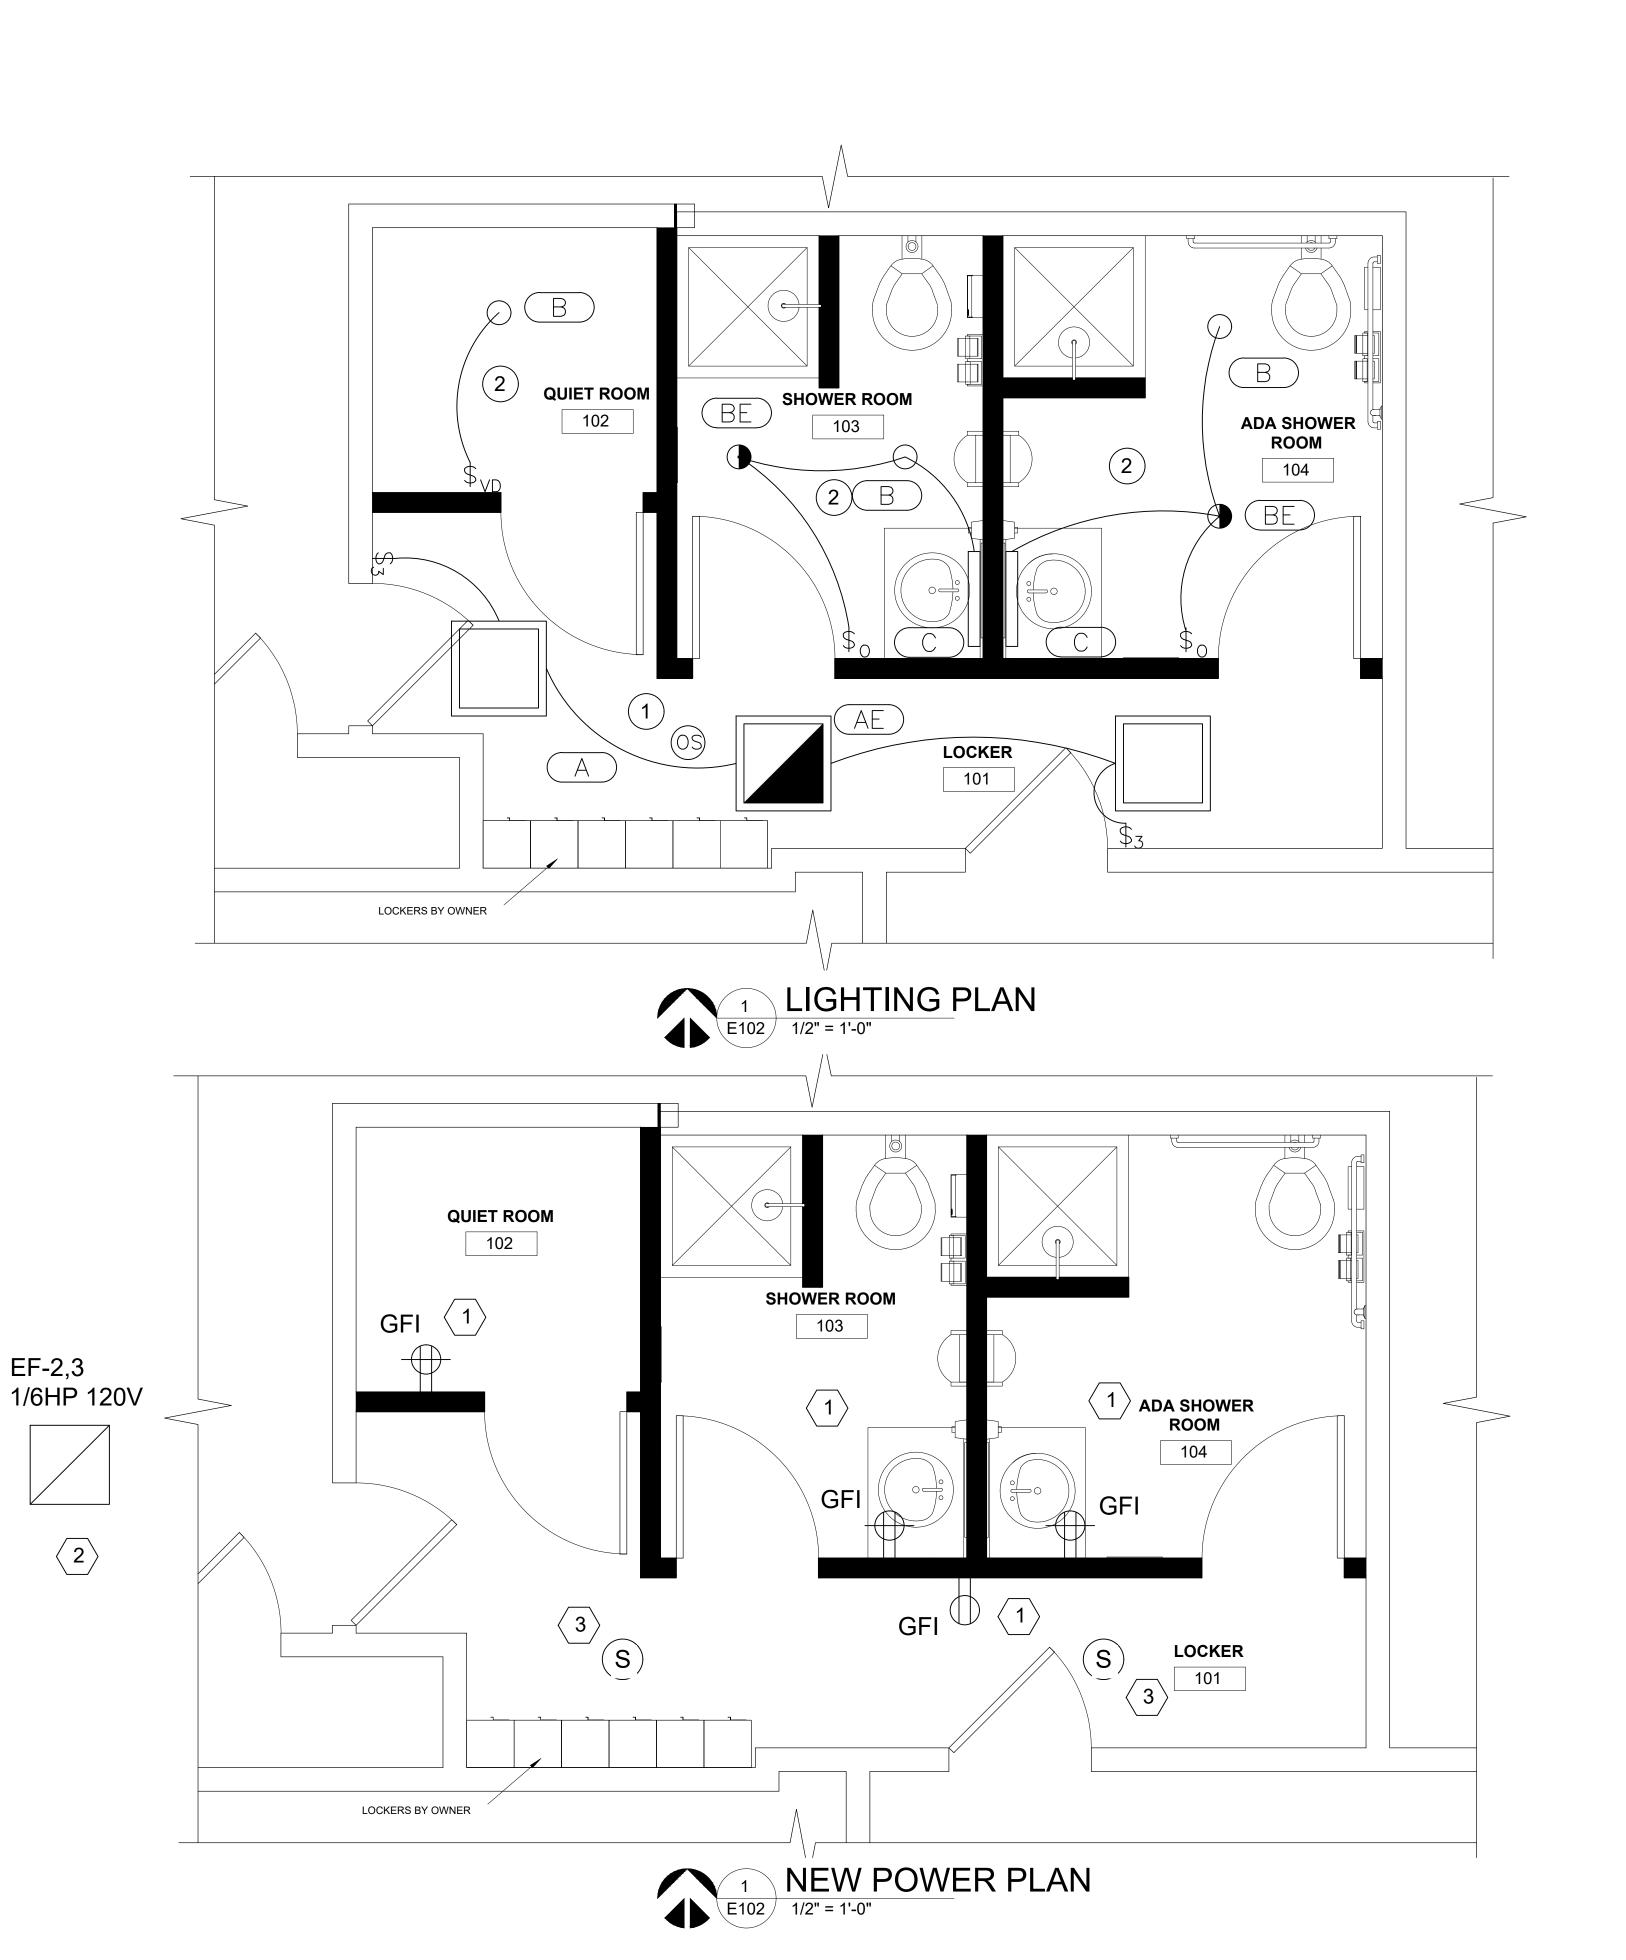
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PROJECT NO. 0242-0408

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ELECTRICAL GENERAL NOTES

6 KEY PLAN


- REFER TO ARCHITECTURAL REFLECTED CEILING PLAN FOR EXACT LOCATION OF A ALL LIGHTING FIXTURES UNLESS OTHERWISE NOTED.
- ANY 120 VOLT BRANCH CIRCUIT FEEDER LONGER THAN 120'-0" TO LAST DEVICE B SHALL BE SIZED TO THE NEXT LARGER STANDARD AWG SIZE. E.C. SHALL FIELD VERIFY ALL LENGTHS OF FEEDERS
- SEE LIGHT FIXTURE SCHEDULE SHEET E100. ALL ELECTRICAL DEVICES ON THIS SHEET SHALL BE NEW UNLESS OTHERWISE NOTED.
- WHERE MORE THEN ONE LIGHT SWITCH IS INDICATED TO BE INSTALLED AT THE SAME LOCATION, THEY SHALL BE GROUPED UNDER ONE COMMON FACEPLATE.
- ELECTRICAL CONTRACTOR SHALL COMPLY WITH THE LATEST NATIONAL ELECTRICAL CODE, LIFE SAFETY CODE AND APPLICABLE STATE AND LOCAL
- CODES AND ORDINANCES. ELECTRICAL EQUIPMENT AND WIRING SHALL BE NEW AND SHALL BE FURNISHED AND INSTALLED BY ELECTRICAL CONTRACTOR, UNLESS OTHERWISE NOTED.
- WIRING SHALL BE IN CONDUIT. CONDUIT SHALL BE 3/4" CONDUIT MINIMUM. CONDUITS IN FINISHED AREAS SHALL BE CONCEALED

(#) NEW LIGHTING WORK KEYED NOTES

- NEW FIXTURES TYPE "A" TO BE CONNECTED/CIRCUITED TO EXISTING CIRCUIT AVAILABLE FROM DEMOLITION. CONTROL THRU CEILING MOUNTED OCCUPACY SENSOR. COORDINATE PLACEMENT OF SENSORS WITH LIGHTING CONTROLS
- NEW LIGHT FIXTURES TO BE CONNECT TO EXISTING CIRCUIT BEING AVAILABLE 2 FROM DEMOLITION WORK. ALL CONDUIT, WIRING AND CONTROLS SHALL BE NEW AS SHOWN.

(#) NEW POWER WORK KEYED NOTES

- NEW GFIC RECEPTACLE TO BE MOUNTED AS SHOWN, AND ARE CONNECTED TO EXISTING RECEPTACLE CIRCUIT BEING AVAILABLE FROM DEMO WORK, UPDATE PANEL SCHEDULE.
- CONNECT NEW EXHAUST FAN EF-2,3 1/6HP 120V TO EXISTNIG CIRCUIT 2 AVAILABLE FROM DEMO OF EXISTING FAN. FAN SHALL BE CONTROLLED FROM EITHER ROOM OCCUPANCY SENSOR LIGHT SWITCH.
- NEW CEILING MOUNTED 8" ROUND SPEAKER. (ONE FROM EACH BUILDING SOUND SYSTEMS) CONNECT TO EXISTING SPEAKER CIRCUIT. EXTEND CONDUIT AND WIRING AS REQUIRED TO NEW LOCATION. VERIFY EXACT LOCATION IN THE FIELD WITH OWNER. NEW SPEAKER SHALL BE BY "JBL SPEAKER" OR EQUAL.

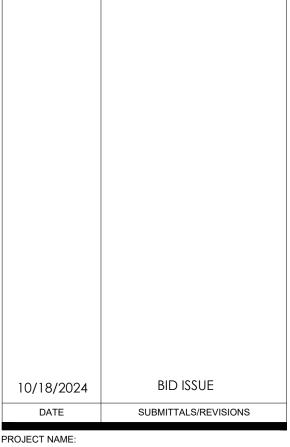


PROJECT NAME:

CLINTON TWP. FIRE STATION RENOVATIONS

SHEET TITLE:

GENERAL ELECTRICAL PLANS

CLINTON TOWNSHIP

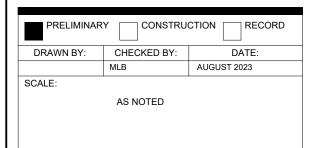

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PROJECT NO.

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ELECTRICAL SPECIFICATIONS

ELECTRICAL TRADES SPECIFICATION

. THE GENERAL CONDITIONS AND SPECIAL CONDITIONS OF THE SPECIFICATIONS SHALL GOVERN. GENERAL CONDITIONS AND SPECIAL CONDITIONS REQUIRE- MENTS RELATED, BUT NOT LIMITED TO, RUBBISH REMOVAL, CUTTING AND PATCHING, OBTAINING AND PAYING FOR REQUIRED LICENSES AND PERMITS, REPLACEMENT OF DAMAGED OR STOLEN EQUIPMENT AND SYSTEMS, COMPLIANCE WITH ALL NATIONAL, STATE AND LOCAL CODES, SHALL APPLY.

2. THE GENERAL CONDITIONS AND SPECIAL CONDITIONS OF THE SPECIFICATIONS SHALL GOVERN. GENERAL CONDITIONS AND SPECIAL CONDITIONS REQUIRE- MENTS RELATED, BUT NOT LIMITED TO, RUBBISH REMOVAL, CUTTING AND PATCHING, OBTAINING AND PAYING FOR REQUIRED LICENSES AND PERMITS, REPLACEMENT OF DAMAGED OR STOLEN EQUIPMENT AND SYSTEMS, COMPLIANCE WITH ALL NATIONAL, STATE AND LOCAL CODES, SHALL APPLY.

3. ENTIRE INSTALLATION SHALL BE PERFORMED IN A FIRST-CLASS WORK-MAN-LIKE MANNER. THE COMPLETED SYSTEMS SHALL BE FULLY OPERATIONAL; ACCEPTANCE BY THE OWNER SHALL BE A CONDITION OF THE CONTRACT. ALL WORK SHALL BE COORDINATED WITH EXISTING CONDITIONS IN ORDER TO AVOID INTERFERENCES, PRESERVE MAXIMUM HEADROOM AND AVOID OMISSIONS.

4 ALL WIRING SHALL BE IN CONDUIT, RIGID OR THIN WALL AS PERMITTED BY CODE. CONDUIT SHALL BE CONCEALED WHERE POSSIBLE; WHERE EXPOSED, RUN IN STRAIGHT LINES PARALLEL AND/OR PERPENDICULAR TO BUILDING CONSTRUCTION.

5. ELECTRICAL CONDUITS SHALL BE RIGID GALVANIZED ASA C80.1 FOR SERVICE ENTRANCE, PANEL FEEDERS AND UNDERGROUND OR IN CONCRETE ENCASEMENT. THINWALL ASA C80.3 FOR BRANCH CIRCUITS, OUTDOOR UNDERGROUND SHALL BE PVC, SCHEDULE 40, WITH CONTINUOUS GROUND.

6. ALL CONDUIT FITTINGS SHALL BE GALVANIZED. ONLY GLAND TYPE, RAIN AND CONCRETE TIGHT, THREADED CONNECTORS AND COUPLINGS ARE APPROVED FOR USE WITH THINWALL CONDUIT.

7. PROVIDE AND INSTALL COMPLETE EMPTY CONDUIT SYSTEM FOR TELEPHONE OUTLETS AS INDICATED ON DRAWINGS. CONDUITS SHALL BE TERMINATED AT TELEPHONE BACKBOARD WITH FIBER BUSHINGS.

8. CONTRACTOR SHALL INCLUDE ALL MISCELLANEOUS ITEMS REQUIRED TO COMPLETE THE WORK, INCLUDING BUT NOT LIMITED TO, THE FOLLOWING: MOVING AND RIGGING OF MATERIAL AND EQUIPMENT, ALL HANGERS, SUPPORTS, ANCHORS, EXPANSION MEANS, CONDUIT, WIRE, FITTINGS AND SLEEVES.

9. CONTRACTOR SHALL INCLUDE ALL TESTING, ADJUSTING & BALANCING AND COORDINATION BETWEEN TRADES. CIRCUITS SHALL BE PROPERLY BALANCED ACROSS PHASES.

10. PRIOR TO ORDERING EQUIPMENT, CONTRACTOR SHALL SUBMIT SHOP DRAWINGS IN QUADRUPLICATE FOR APPROVAL.

11. ALL MATERIALS USED SHALL BE NEW AND BEAR THE U.L. LABEL, WHERE SUCH SERVICE AND LABEL ARE REGULARLY PROVIDED; AND BE OF THE APPROPRIATE NEMA STANDARD.

12. CONTRACTOR SHALL NOT SCALE DRAWINGS FOR DIMENSIONS, BUT SHALL CONTACT PROJECT ARCHITECT FOR ALL DIMENSIONAL DATA. FIELD VERIFY DIMENSIONS AND CONDITIONS PRIOR TO ROUGH-IN.

13. ELECTRICAL CONTRACTOR SHALL PROVIDE ALL TESTS AND INSPECTIONS NECESSARY TO DETERMINE THAT ALL WIRING INSTALLED UNDER THIS SPEC- IFICATION IS IN SATISFACTORY CONDITION AND SHALL BE PERFORMED TO THE SATISFACTION OF THE ELECTRICAL INSPECTOR OF THE LOCAL AUTHORITY AND ALL OTHERS HAVING JURISDICTION OVER THE ELECTRICAL WORK.

14. ELECTRICAL CONTRACTOR SHALL DELIVER THE CERTIFICATES OF INSPECTION AND FINAL APPROVAL TO THE ARCHITECT AS A REQUIREMENT FOR FINAL PAYMENT.

15. ELECTRICAL CONTRACTOR SHALL GUARANTEE IN WRITING ALL WORK IN CONNECTION WITH HIS ELECTRICAL CONTRACT FOR A PERIOD OF ONE (1) YEAR FROM THE DATE OF COMPLETION OF HIS WORK AT NO COST TO THE OWNER.

16. DISCONNECT SWITCHES SHALL BE VISIBLE BLADE, QUICK-MAKE, QUICK-BREAK UNIT WITH PROVISIONS FOR PADLOCKING. SWITCHES SHALL BE SQUARE D. F.P.E., G.E. OR WESTINGHOUSE, OF THE NEMA CLASS AND MATERIAL REQUIRED, LIGHTING AND RECEPTACLE PANELS SHALL BE CIRCUIT BREAKER TYPE WITH THERMAL MAGNETIC, TRIP-FREE, TRIP-INDICATING, INVERSE TIME COMMON TRIP CIRCUIT BREAKERS EQUIPPED WITH SILVER ALLOY CONTACTS AND QUICK-MAKE, QUICK-BREAK MECHANISM. CIRCUIT BREAKERS SHALL BE BOLTED TYPE AND RATED 10,000 A.I.C. MINIMUM (120V) 14,000 A.I.C. (277V). PANELS SHALL BE SQUARE D "NQOD" AND NEHB PANEL BOARDS, G.E. OR WESTINGHOUSE.

17. FURNISH AND INSTALL ALL WIRING AND CONNECTIONS TO ALL MOTORS SHOWN ON THE PLANS. FURNISH AND INSTALL DISCONNECT SWITCHES FOR ALL MOTORS. DISCONNECTING MEANS MUST COMPLY WITH THE NATIONAL ELECTRICAL CODE. ALL MANUAL AND MAGNETIC MOTOR STARTERS SHALL BE SQUARE D CLASS 8536/8538 OR EQUAL, WITH 120 VOLT OPERATION COILS WITH AUXILIARY CONTACTS WHEN REQUIRED FOR CONTROL FUNCTIONS. MOTORS 1/4 HP AND SMALLER THAT ARE NOT UNDER AUTOMATIC CONTROL SHALL BE CONTROLLED WITH SQUARE D CLASS 2510 MANUAL STARTERS OR EQUAL.

SWITCHES FOR MOTORS 1/2 HP AND LARGER SHALL BE FUSED HEAVY-DUTY SWITCHES SIMILAR TO SQUARE D TYPE H HEAVY-DUTY LINE OR G.E. TH WITH FRONT-MOUNTED HANDLE OR EQUAL. USE RAIN TIGHT OUTDOORS.

18. DISCONNECT SWITCHES FOR MOTORS RATED 1/3 HP AND LESS MAY BE A GENERAL USE SWITCH. DISCONNECT

19. WIRE AND CABLE SHALL BE COPPER WITH 98% CONDUCTIVITY AND SHALL MEET THE TESTS, AND STANDARDS SET FORTH BY NEMA, UL AND IPCEA. WIRE SHALL BE COPPER TYPE THHN OR XHHN.

GROUND SYSTEM.

21. CONTRACTOR SHALL VERIFY EXACT LOCATION AND MOUNTING HEIGHTS OF ALL OUTLETS WITH ARCHITECT PRIOR TO INSTALLATION.

22. ELECTRICAL SERVICE SHALL BE AS INDICATED ON DRAWINGS.

23. MANUAL MOTOR STARTERS WITH OVERLOAD PROTECTION SHALL BE USED FOR FRACTIONAL HORSEPOWER MOTORS, ALLEN BRADLEY BULLETIN 600.

24. MINIMUM SIZE OF OUTLET BOXES SHALL BE 4" SQUARE, 1 1/2" DEEP, SUITABLY SECURED FOR THEIR PARTICULAR APPLICATION.

25. ALL SWITCH PLATES, RECEPTACLE PLATES, ETC., TO SATIN FINISH, STAINLESS STEEL UNLESS OTHERWISE REQUIRED BY ARCHITECT.

26. CONTRACTOR SHALL FURNISH AND INSTALL ALL FIXTURES AND LAMPS INCLUDING REPLACEMENTS UNTIL FINAL ACCEPTANCE OF COMPLETED WORK. FLUORESCENT LAMPS SHALL BE COOL WHITE (34 WATT POWER SAVER TYPE). FIXTURES SHALL BEAR THE U.L. LABEL AND BE INSTALLED IN FULL COMPLIANCE WITH APPLICABLE CODES. BALLASTS SHALL BE U/L - ETL - CMB CERTIFIED HIGH POWER FACTOR, SOUND RATED "A", THERMALLY PROTECTED. UPON COMPLETION OF WORK, ALL FIX- TURES SHALL BE CLEANED AND LEFT FREE FROM ALL FOREIGN MATERIAL, DUST, ETC., WITH FUNCTIONING LAMPS. ALL PLASTIC COMPONENTS SHALL BE VIRGIN ACRYLIC. FIXTURES SHALL BE SUPPORTED FROM BUILDING STRUC- TURE, NOT CEILING. FIXTURES IN FURRED SPACES SHALL BE CONNECTED BY MEANS OF FLEXIBLE CONDUIT AND AF WIRE TO OUTLET BOX INDEPENDENT OF FIXTURE.

27. ALL SERVICE WORK MUST CONFORM TO UTILITY COMPANY REQUIREMENTS. CONTACT UTILITY COMPANIES, VERIFY AND CORRELATE SERVICES AND PAY ALL UTILITY COMPANY CHARGES FOR EXTENSIONS, TRANSFORMERS, METERS,

28. PROVIDE GROUND FAULT INTERRUPTERS FOR OUTLETS IN TOILET ROOMS AND AT EXTERIOR OF BUILDING AS REQUIRED BY STATE AND LOCAL CODES.

29. FURNISH AND INSTALL WALL PLATES FOR ALL WIRING DEVICES AND TELEPHONE OUTLETS. IN ALL FINISHED AREAS OF THE BUILDING, PLATES SHALL BE STAINLESS STEEL .040 SATIN FINISH US 32D AS MANUFACTURED BY HUBBELL. OR APPROVED EQUAL.

30. GANG PLATES SHALL BE USED BY ALL GANG MOUNTED DEVICES.

31. NO BOXES SHALL BE LEFT UNCOVERED UNLESS SPECIFICALLY INDICATED.

DUPLEX RECEPTACLE 20A - 125V FLOOR DUPLEX OUTLET WEATHERPROOF CONVENIENCE OUTLET

OUTLET 3 WIRE W/GROUND 20A-208V

SINGLE POLE TOGGLE SWITCH 20A-120V DOUBLE POLE TOGGLE SWITCH

THREE-WAY TOGGLE SWITCH SINGLE POLE TOGGLE SWITCH WITH PILOT LIGHT SPECIAL NATIONAL ELECTRIC CODE (NEC) NOTES:

1. PROPER WORKING CLEARANCE MUST BE PROVIDED AND MAINTAINED ABOUT ALL ELECTRICAL EQUIPMENT ESPECIALLY MAIN SERVICE EQUIPMENT, ALL PANELS, DIS- CONNECTS, TRANSFORMERS, ETC. THEY SHALL BE LOCATED IN DEDICATED SPACES. NO FOREIGN PIPES, DUCTS OR EQUIPMENT PERMITTED IN THESE DEDICATED SPACES. NEC 110-16, TABLE 110-16A AND 384-4.

2. STANDARD RECEPTACLES INSTALLED ON 20 AMP BRANCH CIRCUITS SHALL BE OF THE GROUNDING TYPE. NEC 210-7.

3. ASSUME MINIMUM STANDARDS - 20 AMP BREAKER CIRCUITS, #12 COPPER 90 DEG. C. TYPE CONDUCTORS, 1/2" CONDUIT, ETC. ANYTHING LARGER OR DIFFERENT SHALL BE SO NOTED. NEC 240-3, 240-6, TABLE 310-16 AND CHAPTER 9 TABLE 3A.

4 ALL WIRING (ELECTRICAL, TELEPHONE, ETC.) IN DUCTS, PLENUMS OF OTHER SPACE USED FOR ENVIRONMENTAL AIR SHALL BE INSTALLED IN PROPER RACEWAYS OR CABLES SPECIFICALLY LISTED FOR THE USE. NEC 300-22(B) AND (C).

5. ALL LAMPS FOR TEMPORARY LIGHTING SHALL BE PROTECTED BY A SUITABLE FIXTURE OR LAMPHOLDER WITH A GUARD. NEC 305-4(F).

6. ALL TEMPORARY 125 VOLT, SINGLE PHASE, 15 AND 20 AMP RECEPTACLE OUTLETS SHALL HAVE GFCI PROTECTION. NEC 305-6.

7. FIXTURES IN WET, DAMP OR CORROSIVE LOCATIONS OR IN DUCTS OR HOODS SHALL BE SUITABLE FOR SUCH LOCATIONS AND SO MARKED. NEC 410-4(A), (B), AND (C).

8. ALL FLUORESCENT FIXTURES INSTALLED INDOORS SHALL HAVE THERMAL PROTECTION INTEGRAL WITHIN THE BALLAST. NEC 410-73(E).

9. PROPER THERMAL OVERLOAD PROTECTION SHALL BE REQUIRED FOR ALL MOTORS. NEC 430-31.

10. THE DISCONNECTING MEANS FOR MOTORS SHALL BE A MOTOR-CIRCUIT SWITCH RATED IN HORSEPOWER. A CIRCUIT BREAKER, OR A MOLDED CASE SWITCH (NON-AUTOMATIC CIRCUIT INTERRUPTER) AND FOR A CORD AND PLUG-CONNECTED MOTOR, A HORSE- POWER RATED ATTACHMENT PLUG AND RECEPTACLE. NEC 430-109 AND EX. 5.

11. PROPER WIRING METHODS SHALL BE REQUIRED IN PLACES OF ASSEMBLY OF 100 OR MORE PERSONS. NON-METALLIC SHEATHED (ROMEX) CABLE SHALL NOT BE PERMITTED. NEC 518-1, 518-2 AND 518-4.

12. ALL BATTERY BACK-UP EXIT AND EMERGENCY LIGHTS SHALL BE FED FROM THE SAME CIRCUIT AS NORMAL LIGHTING IN THEIR RESPECTIVE AREAS AND BE CONNECTED AHEAD OF ANY LOCAL SWITCHES. NEC700-16, 700-17 AND 700-12(F). BATTERY BACK-UP EXIT AND EMERGENCY LIGHTS CANNOT FEED FROM CIRCUITS OTHER THAN THE NORMAL LIGHTING IN THEIR RESPECTIVE AREAS. INCLUDE LOCK-OPEN DEVICES.

13. MAIN SERVICE DISCONNECTING MEANS SHALL BE PERMANENTLY MARKED TO IDENTIFY IT AS A SERVICE DISCONNECTING MEANS. NEC 230-70(B).

14. ALL SERVICE ENTRANCE AND/OR FEEDER CONDUCTORS NOTED SHALL BE 90 DEG. C. COPPER TYPE MINIMUM FOR PROPER CAPACITY. NEC 230-42(A), 215-2 AND TABLE 310-16.


15. PROPER TYPE AND SIZE OF SERVICE GROUNDING CONDUCTER REQUIRED WITH CONNECTION TO BOTH THE METAL UNDERGROUND WATER PIPING SYSTEM AND A SUPPLEMENTAL ELECTRODE. NEC 250-23(A), 250-81, 250-83 AND TABLE 250-94.

16. CONTINUOUS LOADS SHALL NOT EXCEED 80% OF THE RATING OF THE BRANCH CIRCUIT. NEC 210-22(C) AND 384-16.

17. LIGHTING FIXTURE SCHEDULE SEE LIGHTING PLAN FOR SCHEDULE

18. SMOKE DETECTORS, HEAT SENSORS AND ALARMS CEILING SMOKE DETECTORS (BY OWNER).

19. DUCT SMOKE DETECTORS THE DUCT DETECTORS SHALL BE SERIES DDP PHOTO-ELECTRIC TYPE WITH RATE COMPENSATED/ FIXED SENSITIVITY CIRCUITRY TO DETECT BOTH FAST AND SLOW BURNING FIRES. THE DETECTOR SHALL COME COMPLETE WITH SEALED HOUSING AND SAMPLING TUBES. THE DETECTORS SHALL BE 4-WIRE TYPE WITH AN ISOLATED 24VDC POWER FEED REQUIREMENT TO INSURE RELIABLE OPERATION OF THE AUXILLIARY CONTROL RELAY. A POWER SUPERVISORY RELAY SHALL BE PROVIDED FOR EACH ZONE OF DUCT DETECTORS. DETECTORS SHALL BE WIRED TO THE RESPECTIVE FAN CONTROL FOR SHUT-DOWN UPON ALARM. LOCATE DETECTOR IN SUPPLY DUCT NEAR EACH OF THE TWO (2) FURNACES AND WITHIN THE FURNACE ROOM. FURNISH AND INSTALL BY THE ELECTRICAL CONTRACTOR. COORDINATE WITH HVAC

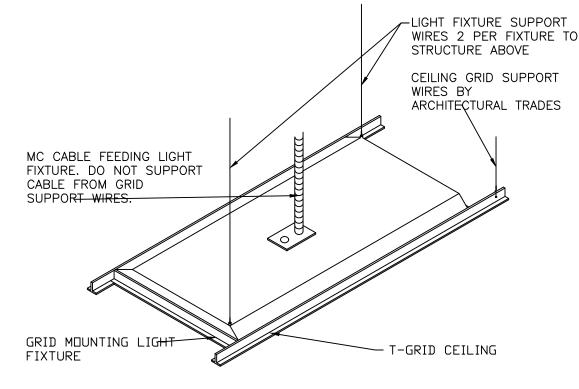


T-GRID FIXTURE MOUNTING DETAIL


ELECTRICAL FIXTURES

1. PENDANT MOUNTED FIXTURES SHALL BE DIRECTLY SUPPORTED FROM THE STRUCTURE ABOVE USING A 9 GAUGE WIRE OR AN APPROVED ALTERNATE SUPPORT WITHOUT USING THE CEILING SUSPENSION SYSTEM FOR DIRECT SUPPORT.


2. TANDEM FIXTURES MAY UTILIZE COMMON WIRES.

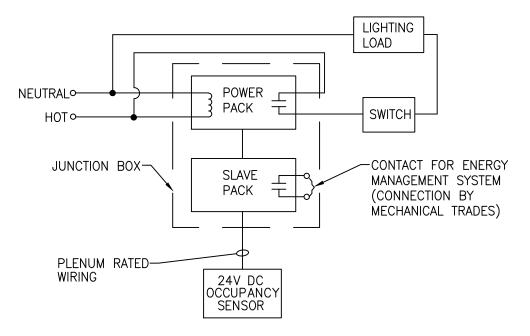

CEILING MOUNTED OCCUPANCY SENSOR DETAIL

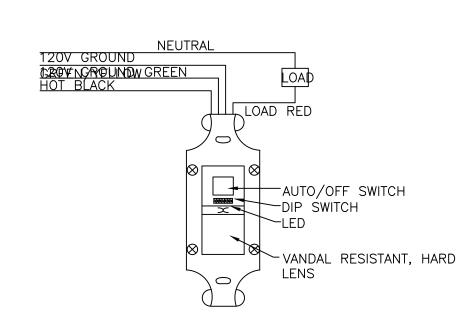

OFFICE VACANCY **SENSOR SCHEMATIC** NO SCALE

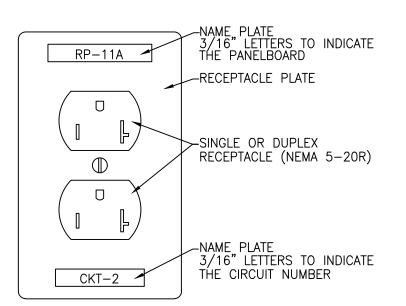

DETAIL OF BRANCH CIRCUIT NUMBER ON RECEPTACLE PLATE NO SCALE



ANDERSON, ECKSTEIN AND WESTRICK, INC.

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BID ISSUE 10/18/2024 DATE SUBMITTALS/REVISIONS PROJECT NAME:

CLINTON TWP. FIRE STATION RENOVATIONS

ELECTRICAL SCHEDULES

CLINTON TOWNSHIP

☐ CONSTRUCTION ☐ DRAWN BY: CHECKED BY: MLB AUGUST 2023 SCALE: AS NOTED

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UTILITY INFORMATION, AS SHOWN, INDICATES APPROXIMATE LOCATIONS AND TYPES OF EXISTING FACILITIES ONLY, AS DISCLOSED BY RECORDS PROVIDED TO THIS FIRM FROM THE VARIOUS UTILITY COMPANIES. NO GUARANTEE IS GIVEN OR IMPLIED AS TO THE COMPLETENESS OR ACCURACY THEREOF

PRIOR TO CONSTRUCTION, ALL LOCATIONS AND DEPTHS OF EXISTING OVERHEAD AND UNDERGROUND UTILITIES (IN CONFLICT WITH THE CONSTRUCTION OF THESE PROPOSED IMPROVEMENTS) SHALL BE VERIFIED IN THE FIELD. DURING THE CONSTRUCTION, THE CONTRACTOR SHALL PROTECT AND SUPPORT ALL UTILITIES THAT ARE ENCOUNTERED. (ALL COSTS FOR UTILITY LOCATION VERIFICATION, SUPPORT AND PROTECTION SHALL BE INCLUDED IN THE PROPOSED PAY ITEM CONFLICTING WITH THAT UTILITY).

DURING CONSTRUCTION, THE CONTRACTOR SHALL USE EXTREME CAUTION WHEN OPERATING NEAR ANY AND ALL OVERHEAD AND / OR BURIED UTILITIES.

0242-0417 M:\0242\0242-0417\Arch\CAD\Drawings\Clinton Township Station 2 & 3.rvt